156 EAST 71 ST, NEW YORK, NY LANDMARKS SUBMISSION LPC-24-00000



FRONT FACADE

REAR FACADE

LANDMARKS SHEET L

			LANDMAR
Sheet Numbe	er		
L-001.00		TITLE SHEET	-
L-001.00			I, LEGEND, LANDN
L-002.00		BLOCK PLAN	
L-004.00		BLOCK PLAN	
L-005.00			OTO AND 2024 SIT
L-101.00			& PROPOSED PL
L-102.00			& PROPOSED PL
L-103.00			& PROPOSED PL
L-104.00			& PROPOSED PL
L-105.00		DEMOLITION	& PROPOSED PL
L-106.00		PROPOSED I	PLAN - FOURTH FL
L-107.00		PROPOSED I	BULK HEAD AND F
L-201.00		DEMOLITION	& PROPOSED EL
L-202.00		PROPOSED I	FRONT ELEVATIO
L-203.00		EXSISTING F	RONT FACADE CL
L-204.00		FRONT YARE	O AND AREAWAY
L-205.00		PROPOSED I	FRONT FACADE
L-206.00		FRONT YARE	O AND AREAWAY
L-207.00		DEMOLITION	& PROPOSED EL
L-208.00		PROPOSED I	REAR ELEVATION
L-209.00		EXSISTING R	EAR FACADE CLC
L-210.00		PROPOSED I	REAR FACADE
L-211.00		WINDOW- AN	ID DOOR SCHEDU
L-212.00			IDOW DETAILS
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L-301.00			BUILDING SECTIO
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@ B	- AT		LAV. LGT.
B.C.	- BY CC	NTRACTOR	M
BLDG.	- BUILD		
B.O.	- BY OV	VNER	MAT.
C	~		MAX.
CL CL.	- CENTI - CLOSI	ER LINE	MECH. MIN.
CLG.	- CEILIN		MANF. MAT. MAX. MECH. MIN. MTL.
CONT.		INUOUS	N
CONC.	- CONC		N.I.C.
CU/FT	- CUBIC		NO.
D DET.	- DEPAI - DETAI	RTMENT	NOM. N.T.S.
DET. DIM.	- DETAI		0 0
DN.	- DOWN		0.C. ·
DR.	- DOOR		OP'G.
DWG.	- DRAW	ING	P

EXIST. F	- EXISTING	MECH. MIN.	-
' FIN. FL./FLR.	- FINISH - FLOOR	MTL.	-
FL./FLK. F.P. G	- FIREPROOFING	N.I.C. NO.	-
G GA. GALV.	- GAUGE - GALVANIZED	NO. NOM. N.T.S.	-
G.C.	- GENERAL CONTRACTOR	0 0.C.	-
GLS. G.V. GYP.BD./GWD.	- GLASS - GAS VALVE - GYPSUM BOARD	OP'G.	-
ORAWI	NG CON	VEN	TIC
DETAIL NUMBER	2	GR	ID LINE
WHERE DWG. ORIGINATED —	A101	7	
SECTION NUMBE		ELE	EVATIO
WHERE DWG. ORIGINATED —	A301	7	
SHEET NUMBER			rtitioi
SHEET NUMBER	-4 A301 3	PA 2	RTITIO

- ELEVATION

- ELECTRIC

- ENTRANCE

- EQUIPMENT

- EQUAL

- ENCLOSURE

EL./ ELEV.

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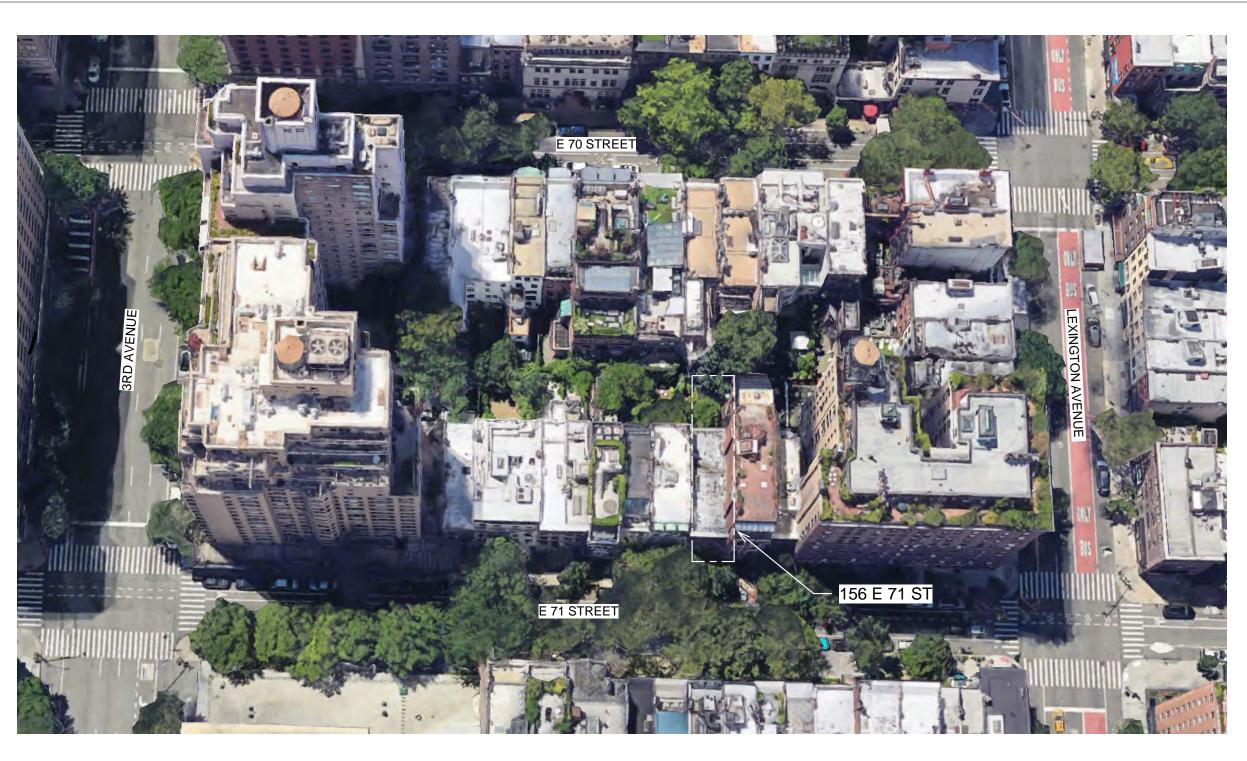
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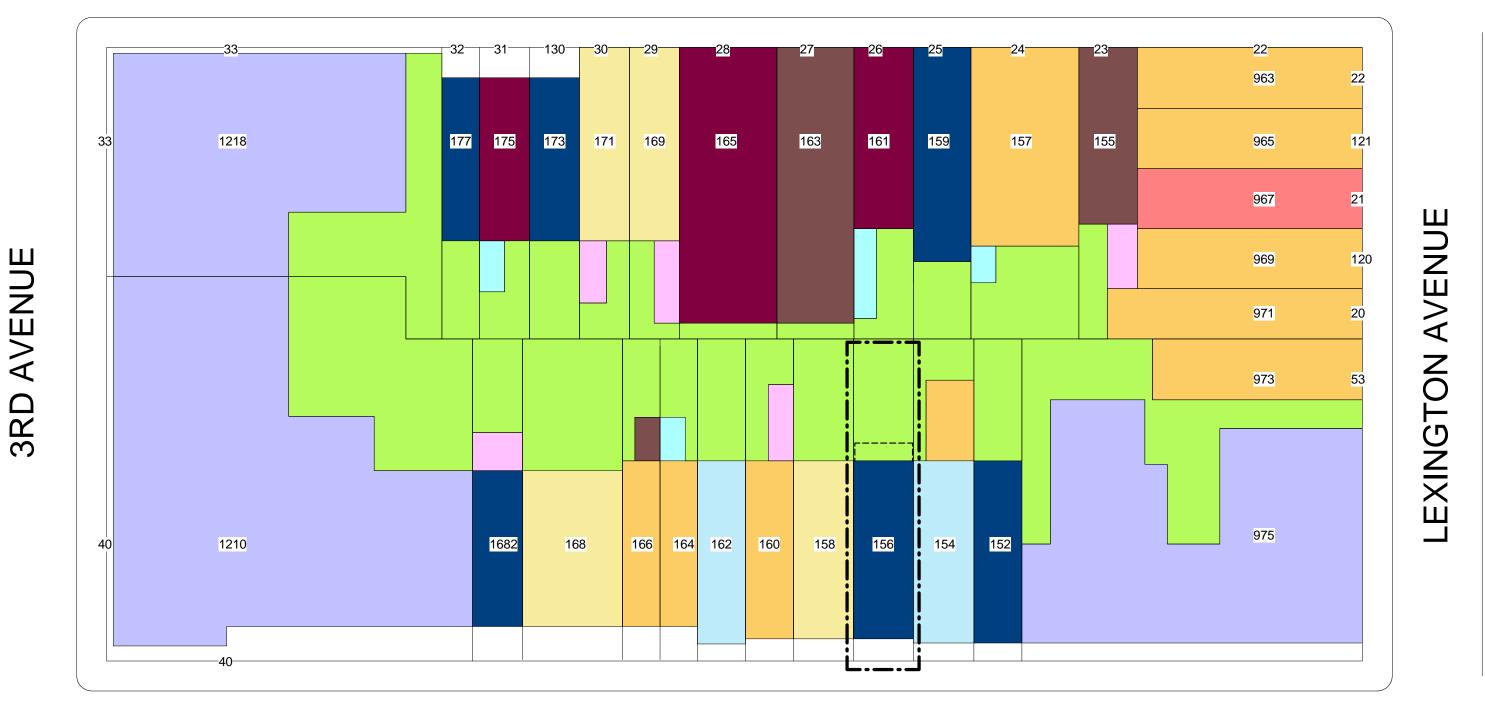
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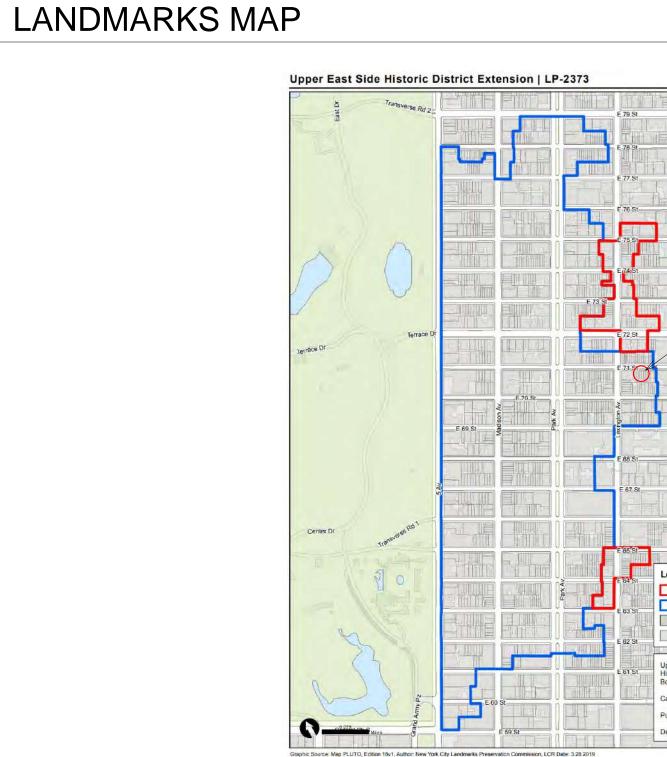
7			156 E 71 ST
			156 EAST 71 STREET
			Architect
			Daniel Kaplan, RA Bowerbird Architects, PLLC 124 9th St. Suite 250 Brooklyn NY 11215 Tel: 917.447.7855
_IST			Owner Steel Property Group
ARKS SHEET LIST			
Sheet Nam			Code Consultant
DMARKS MAP AND AERI	AL VIEW		Reuven Kalish
SITE VISIT PHOTO PLAN - CELLAR PLAN - BASEMENT PLAN - FIRST FLOOR PLAN - SECOND FLOOR			reuven@professionalzoning.com
PLAN - THIRD FLOOR FLOOR ROOF PLAN			Structural Engineer
ELEVATIONS - FRONT FA ON AND NEIGHBORING CLOSE UP PHOTOS			Aleksandr Yaker, PE Yaker Engineering, PC 1679 E 19th St., Ste 2A Brooklyn, NY 11229
(ELEVATIONS - REAR FAC N AND NEIGHBORING B			Cell: (917) 518-2032 Fax: (718) 376-1283
LOSE-UP PHOTOS	TAILS		MEP Engineer Dmitry Levin, PE
YPICAL WINDOW CLOSE ENTRY DOOR CLOSE-UF			 Levin Engineering PLLC 28 Dooley Street,
ON PH			 2nd Floor Brooklyn, NY 11235 Tel. (718) 332-2266
SORROUNDINGS FROM LEXINGTON AVE	NUE		
	Р		LANDMARKS SUBMISSION
- HEIGHT - HOUR	P PART. PL/PLAS.	- PARTITION - PLASTER	01/06/2025 DOB APPLICATION NO.: B01026912-I1
- INSULATION	P.L. R	- PROPERTY LINE	
- LAVATORY - LIGHT	r. RAD. RCP.	- RADIUS - RADIATOR - REFLECTED	DOB EXAMINER - SEAL & SIGNATURE
- MANUFACTURER - MATERIAL - MAXIMUM	REMV. REQ'D. RM.	CEILING PLAN - REMOVE - REQUIRED - ROOM	
- MECHANICAL - MINIMUM - METAL	S SECT. SHELV'G SHT.	- SECTION - SHELVONG - SHEET	
- NOT IN CONTRACT - NUMBER - NOMINAL	SIM. SPEC. SQ. FT./S.F.	- SIMILAR - SPECIFICATION - SQUARE FEET	
- NOT TO SCALE - ON CENTER	S.S./ST. STEEL STD. STL.	STAINLESS STEEL - STANDARD - STEEL	DATE REVISION
- OPENING - PARTITION	STOR. STRUCT. SQ./YD	- STORAGE - STRUCTURAL - SQUARE YARD	
- PLASTER - PROPERTY LINE	T TBD	- TO BE	PROJECT
- MANUFACTURER - MATERIAL - MAXIMUM - MECHANICAL - MINIMUM	TEL. THK. T.O. TOT.	DETERMINED - TELEPHONE - THICK/THICKNESS - TOP OF - TOTAL	156 EAST 71 STREET
- METAL - NOT IN CONTRACT - NUMBER	TYP. U U.O.N.	- TYPICAL - UNLESS OTHERWISE	
- NOMINAL - NOT TO SCALE	V V.I.F.	NOTED - VERIFY IN FIELD	TITLE SHEET
- ON CENTER - OPENING	W WAINS. W.I.C.	- WAINSCOT - WALK IN CLOSET	
ONS			
		DOW NUMBER	ZONING DISTRICTR8BBLOCK1405ZONING MAP8CLOT47
	ROO	M NAME	SEAL & SIGNATURE DATE 02/18/22 JOB NO.: 0147 SCALE: AS NOTED DRAWING NO.: DRAWING NO.:
	DOO	R INDICATOR	L-001.00

REAR YARDS BETWEEN E 70 ST & E 71 ST, 3RD AV & LEXINGTON AV



PLOT PLAN: ENTIRE BLOCK BETWEEN LEXINGTON AV AND 3RD AV (FROM NYC ZOLA, GOOGLE MAPS AND PHOTOS)







E 71 TH STREET



	156 E 71 ST
NYCE Landmarks Presentation Commission	156 EAST 71 STREET
	Architect
	Daniel Kaplan, RA
	Bowerbird Architects, PLLC 124 9th St. Suite 250
— 156 EAST 71 STREET	Brooklyn NY 11215 Tel: 917.447.7855
3M	Owner Steel Property Group
	Code Consultant
	Reuven Kalish reuven@professionalzoning.com
Legend Historic District Extension Boundary	
Historic District Boundary Building Footprints	Structural Engineer
Very York City Tax Lots	Aleksandr Yaker, PE
Historic District Extension LP-2373 Borough of Manhattan Calendared: June 23, 2009	Yaker Engineering, PC 1679 E 19th St., Ste 2A
Public Hearing: October 27, 2009 Designated: March 23, 2010	Brooklyn, NY 11229 Cell: (917) 518-2032
	Fax: (718) 376-1283
	MEP Engineer
	Dmitry Levin, PE Levin Engineering PLLC 28 Dooley Street,
	20 Dooley Street, 2nd Floor Brooklyn, NY 11235
	Tel. (718) 332-2266
	LANDMARKS SUBMISSION 01/06/2025
	DOB APPLICATION NO.: B01026912-I1
	DOB EXAMINER - SEAL & SIGNATURE
	DATE REVISION
	PROJECT
	156 EAST 71 STREET
	TITLE
	BLOCK PLAN, LEGEND, LANDMARKS MAP AND
	AERIAL VIEW
	ZONING DISTRICT R8B BLOCK 1405
	ZONING MAP8CLOT47SEAL & SIGNATUREDATE07/31/24
3 STORY 4 STORY	JOB NO.: 0147 SCALE: AS NOTED
	SCALE: AS NOTED DRAWING NO.:
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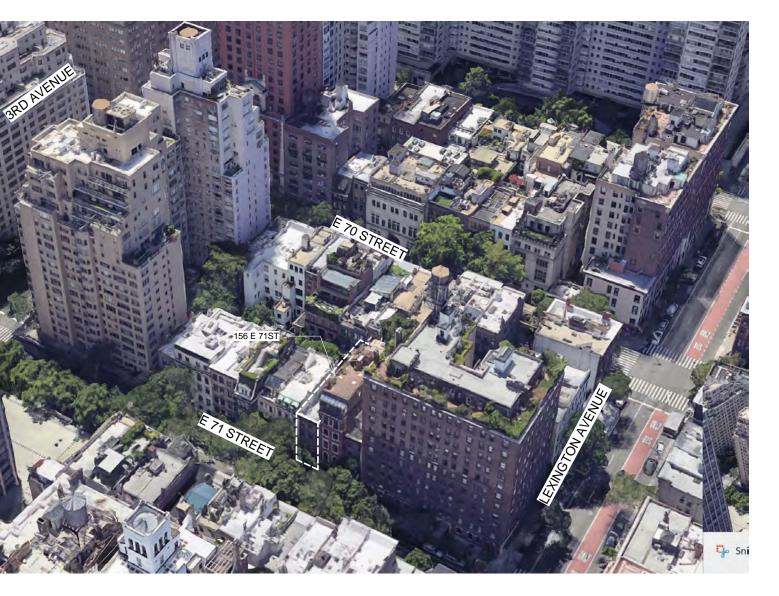


BLOCK PHOTO - TOP VIEW




BLOCK PHOTO - VIEW FROM 156 EAST 71 ST LOOKING WEST





BLOCK PHOTO - REAR YARDS BETWEEN LEXINGTON AV & 3RD AV & E 70 ST & E 71 ST

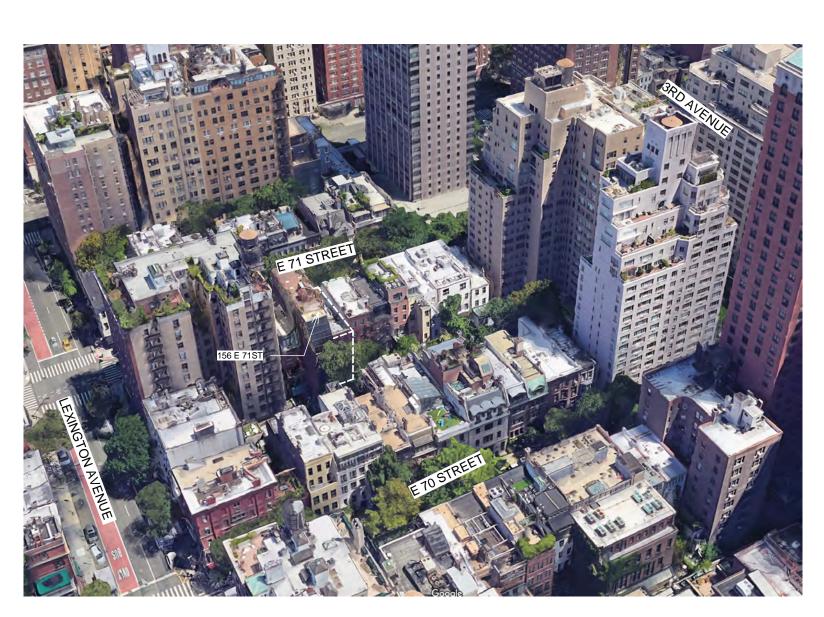

BLOCK PHOTO - REAR YARDS BETWEEN LEXINGTON AV & 3RD AV & E 70 ST & E 71 ST

BLOCK PHOTO - VIEW FROM 156 EAST 71 ST LOOKING NORTH

LEXINGTON AVENUE



BLOCK PHOTO - VIEW FROM 156 EAST 71 ST LOOKING EAST

- 71 ST STREET

156 E 71 ST

156 EAST 71 STREET

Architect

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Owner

Steel Property Group

Code Consultant

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DOB APPLICATION NO.: B01026912-I1

DOB EXAMINER - SEAL & SIGNATURE

DATE	REVISION

PROJECT

156 EAST 71 STREET

TITLE **BLOCK PLAN PHOTOS**

ZONING DISTRICT	R8B	BLOCK	1405
ZONING MAP	8C	LOT	47
SEAL & SIGNATURE		DATE	07/31/24
DARC		JOB NO.:	0147
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156 E 71 ST

156 EAST 71 STREET

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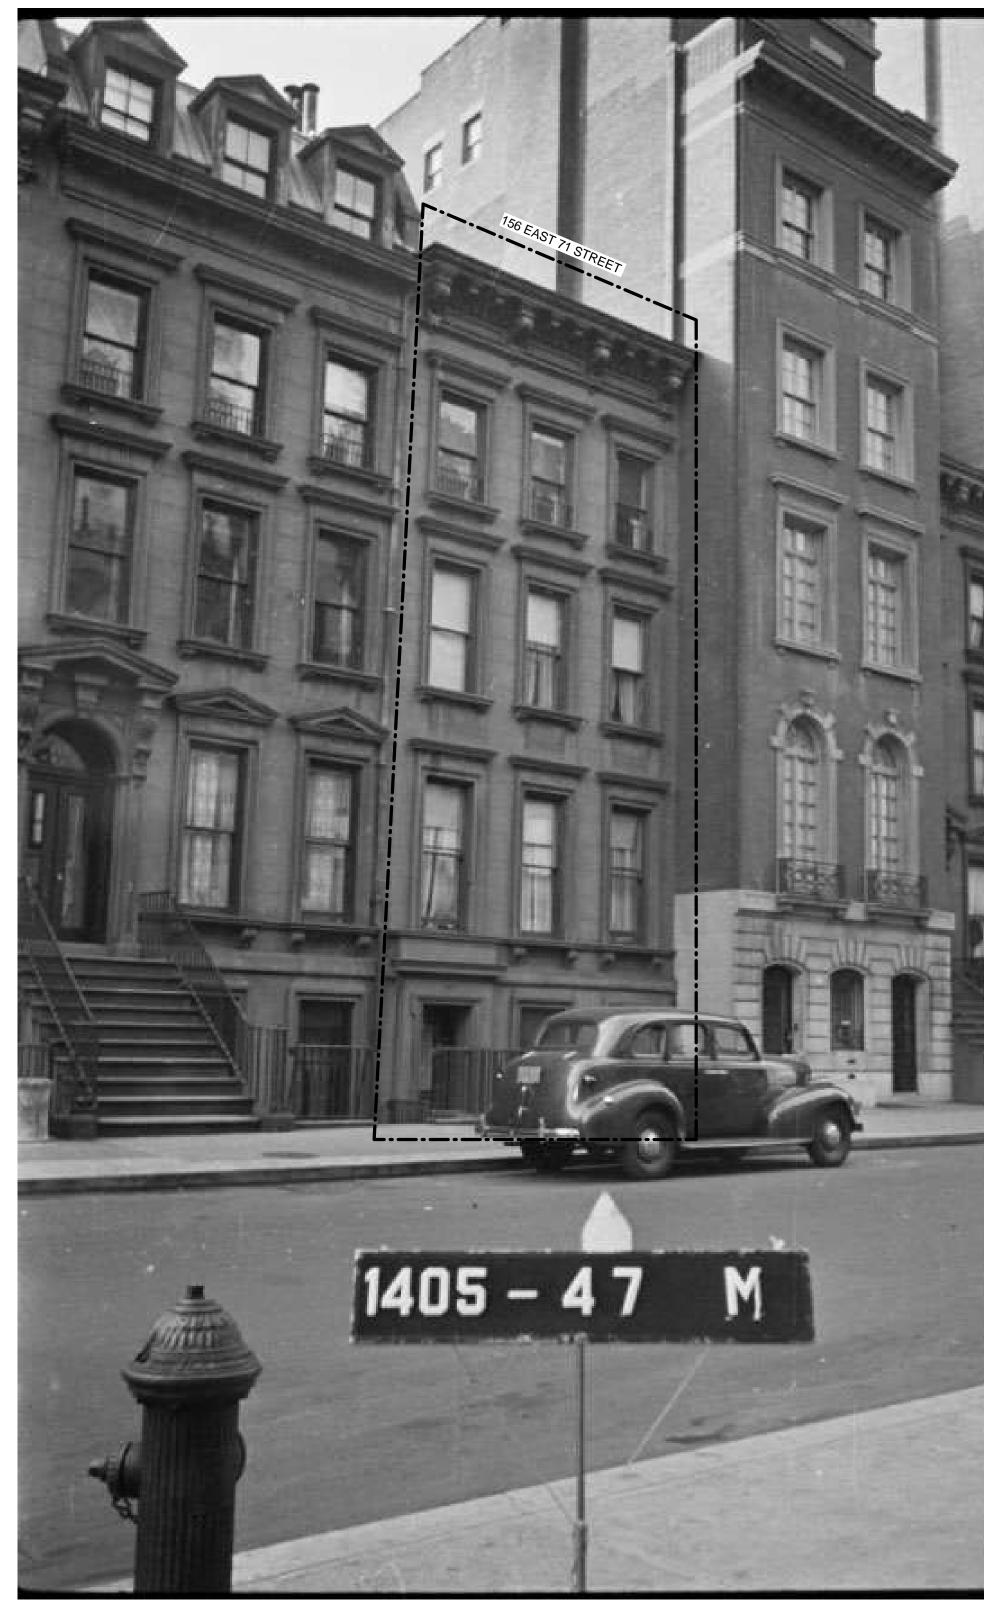
REVISION

PROJECT

156 EAST 71 STREET

BLOCK PLAN PHOTOS

ZONING DISTRICT	R8B	BLOCK	1405
ZONING MAP	8C	LOT	47
SEAL & SIGNATURI		DATE	07/31/24
DARC		JOB NO.:	0147
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SEAL & SIGNATURI		L-00	4.00



156 EAST 71 ST : TAX PHOTO





156 EAST 71 ST : SITE VISIT PHOTO



156 E 71 ST

156 EAST 71 STREET

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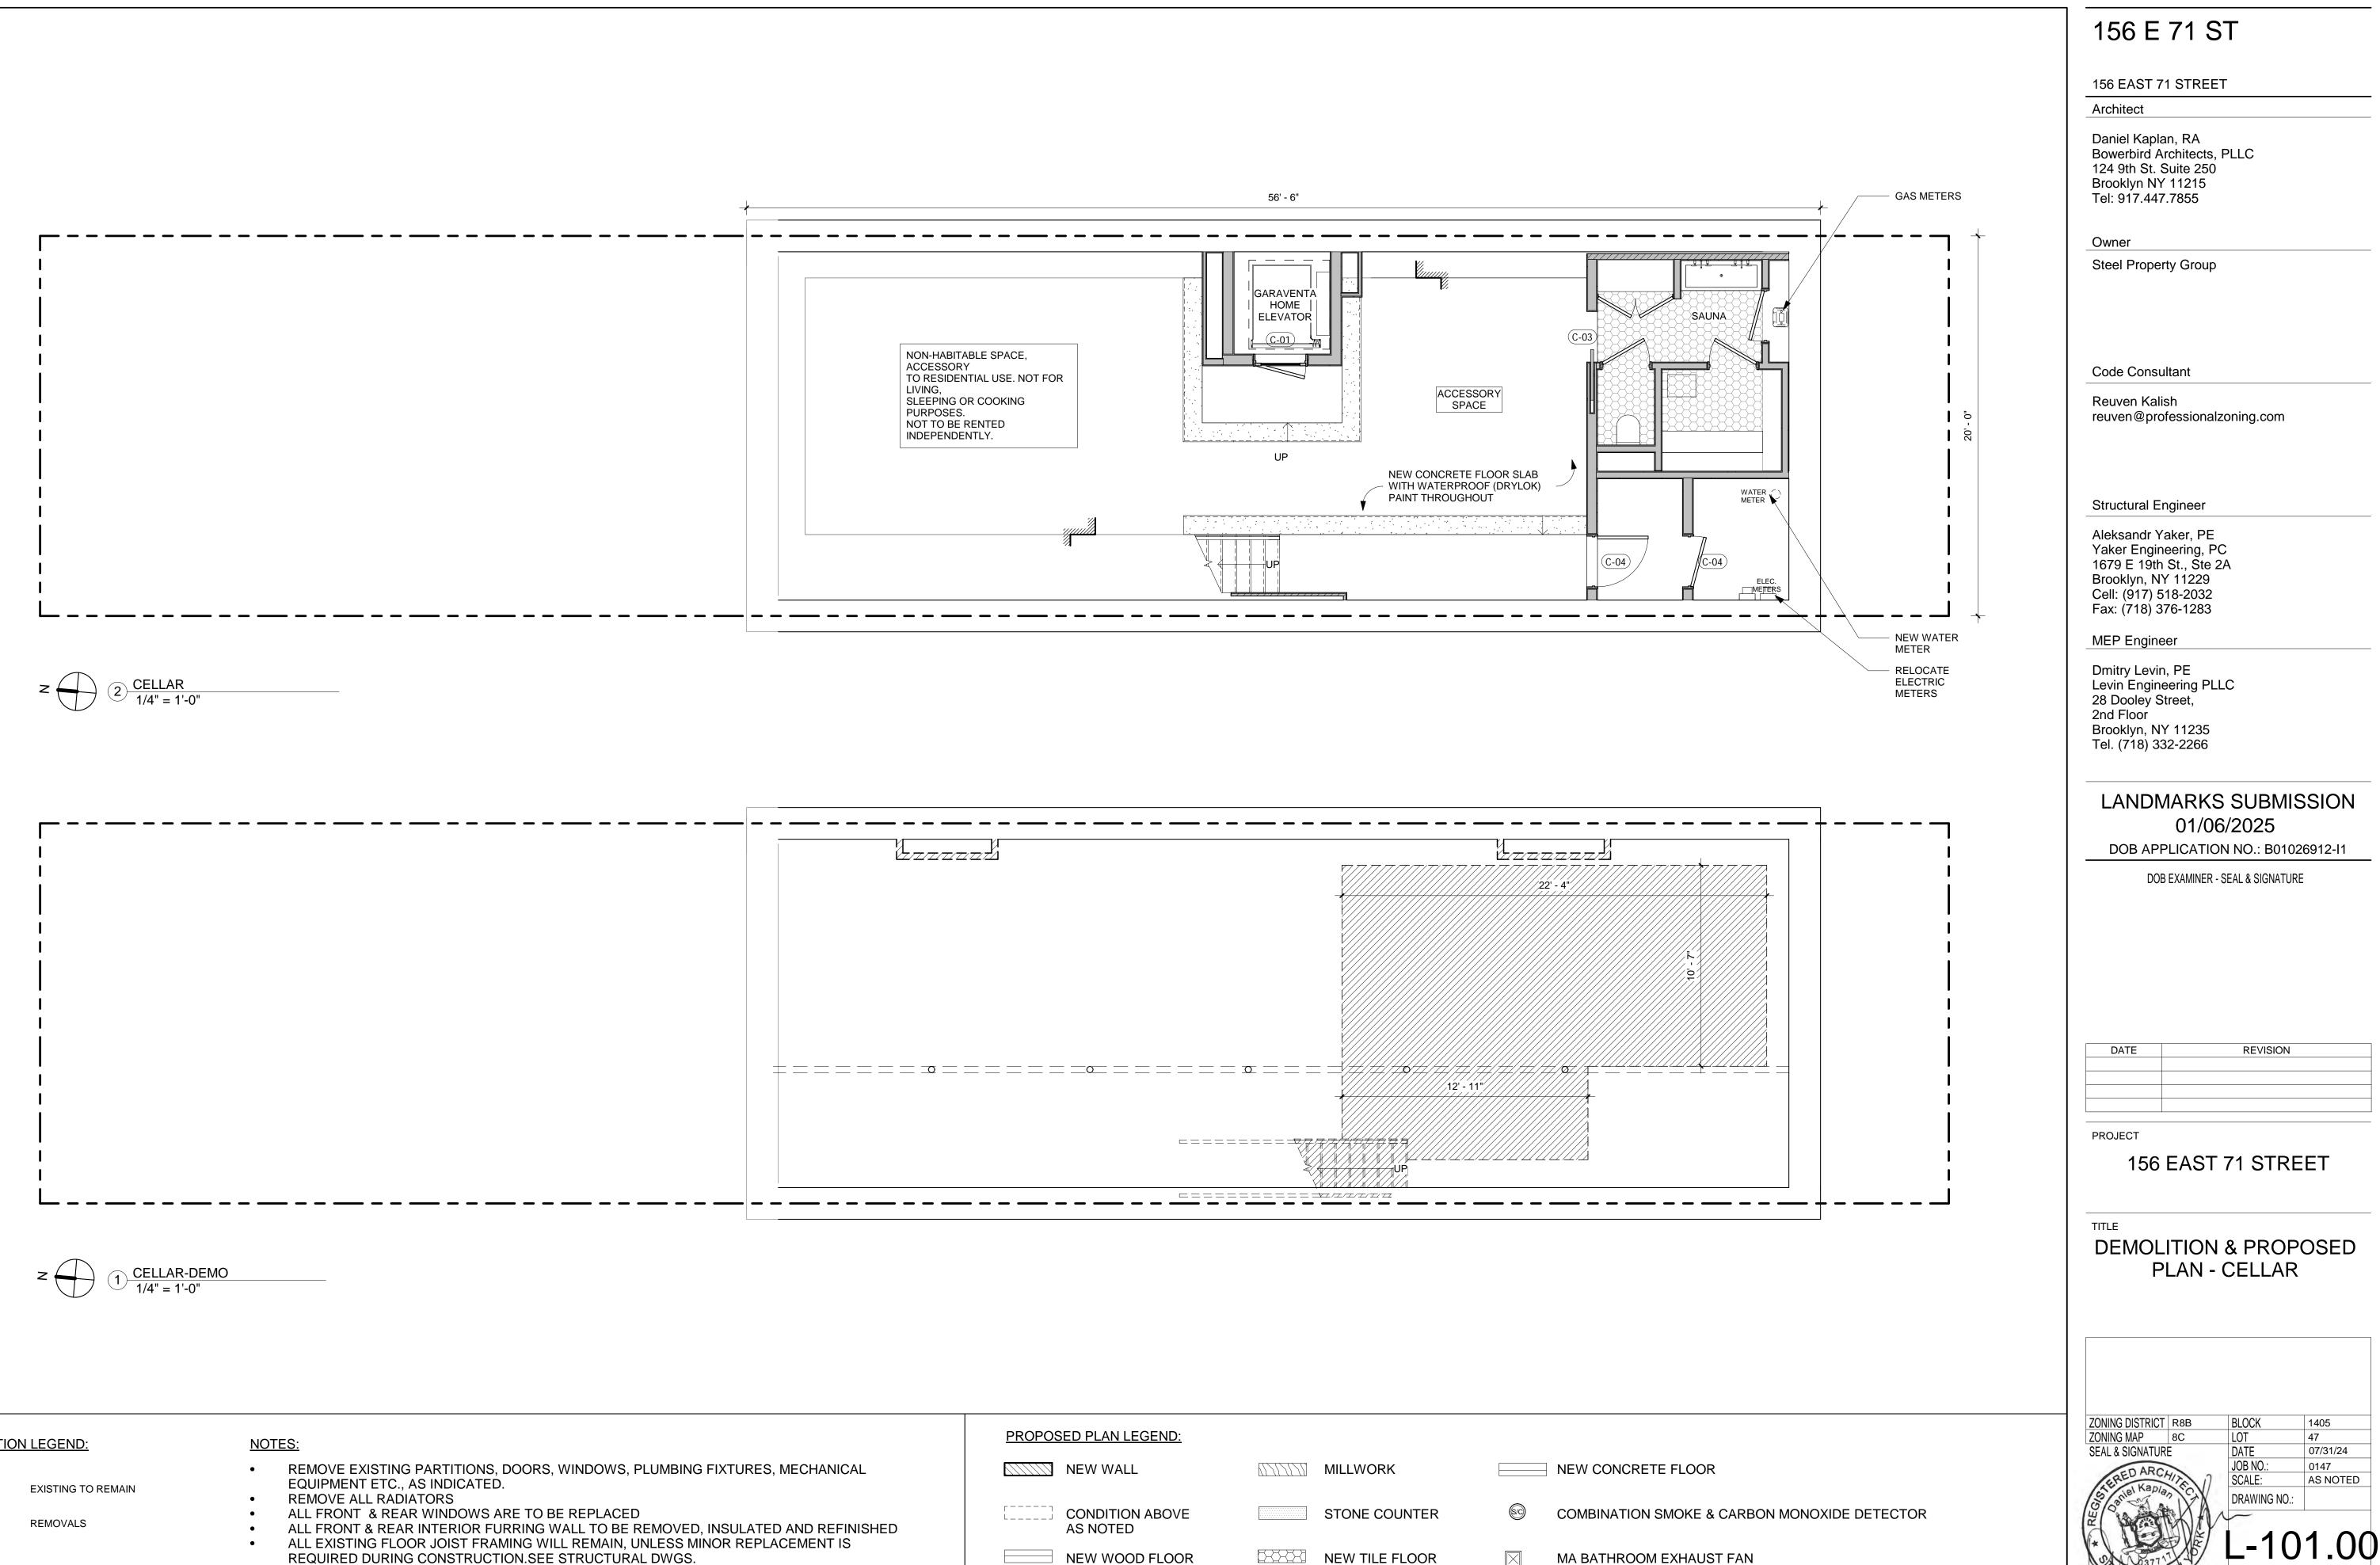
DATE	REVISION

PROJECT

156 EAST 71 STREET


1940 TAX PHOTO AND 2024 SITE VISIT PHOTO


ZONING DISTRICT	R8B	BLOCK LOT	1405
ZONING MAP SEAL & SIGNATURE	8C	DATE	07/31/24
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DEMOLITION LEGEND:

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REQUIRED DURING CONSTRUCTION.SEE STRUCTURAL DWGS.

HANICAL	NEW WALL	MILLWORK	NEW CONCRETE FLOOR
D REFINISHED	CONDITION ABOVE	STONE COUNTER	COMBINATION SMOKE & CAR
ENT IS	NEW WOOD FLOOR		

156 E 71 ST

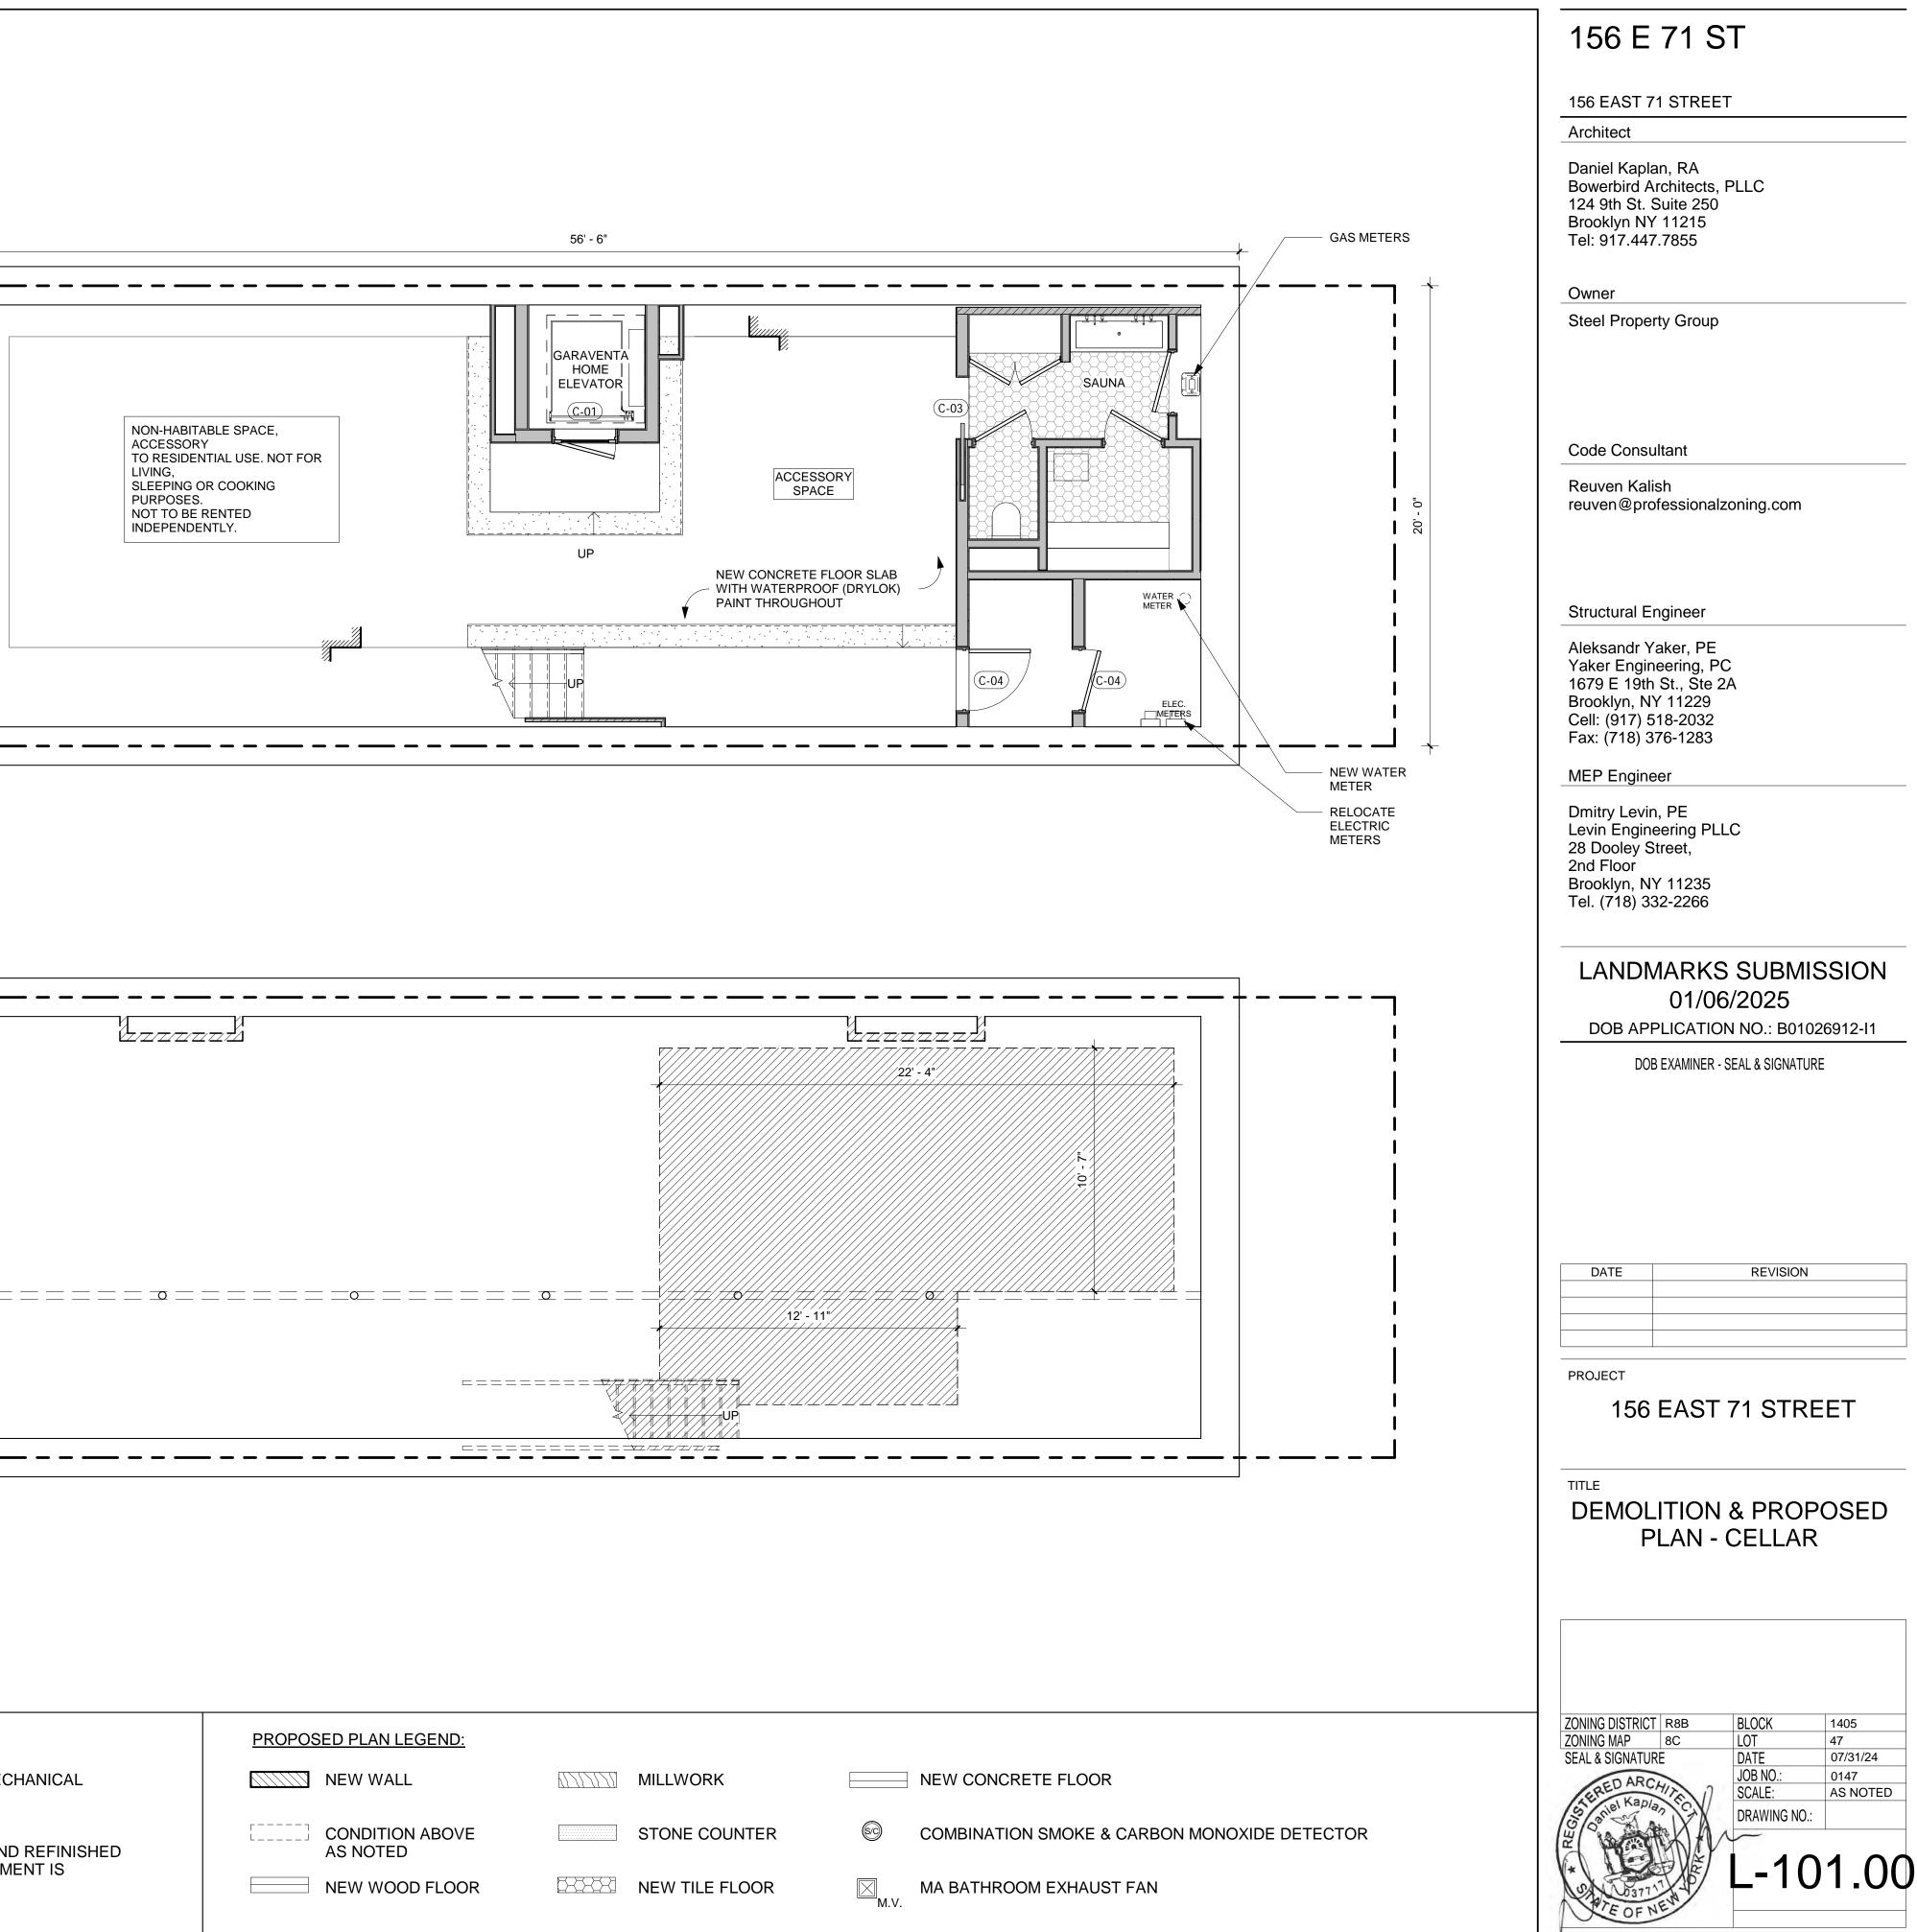156 EAST 71 STREET
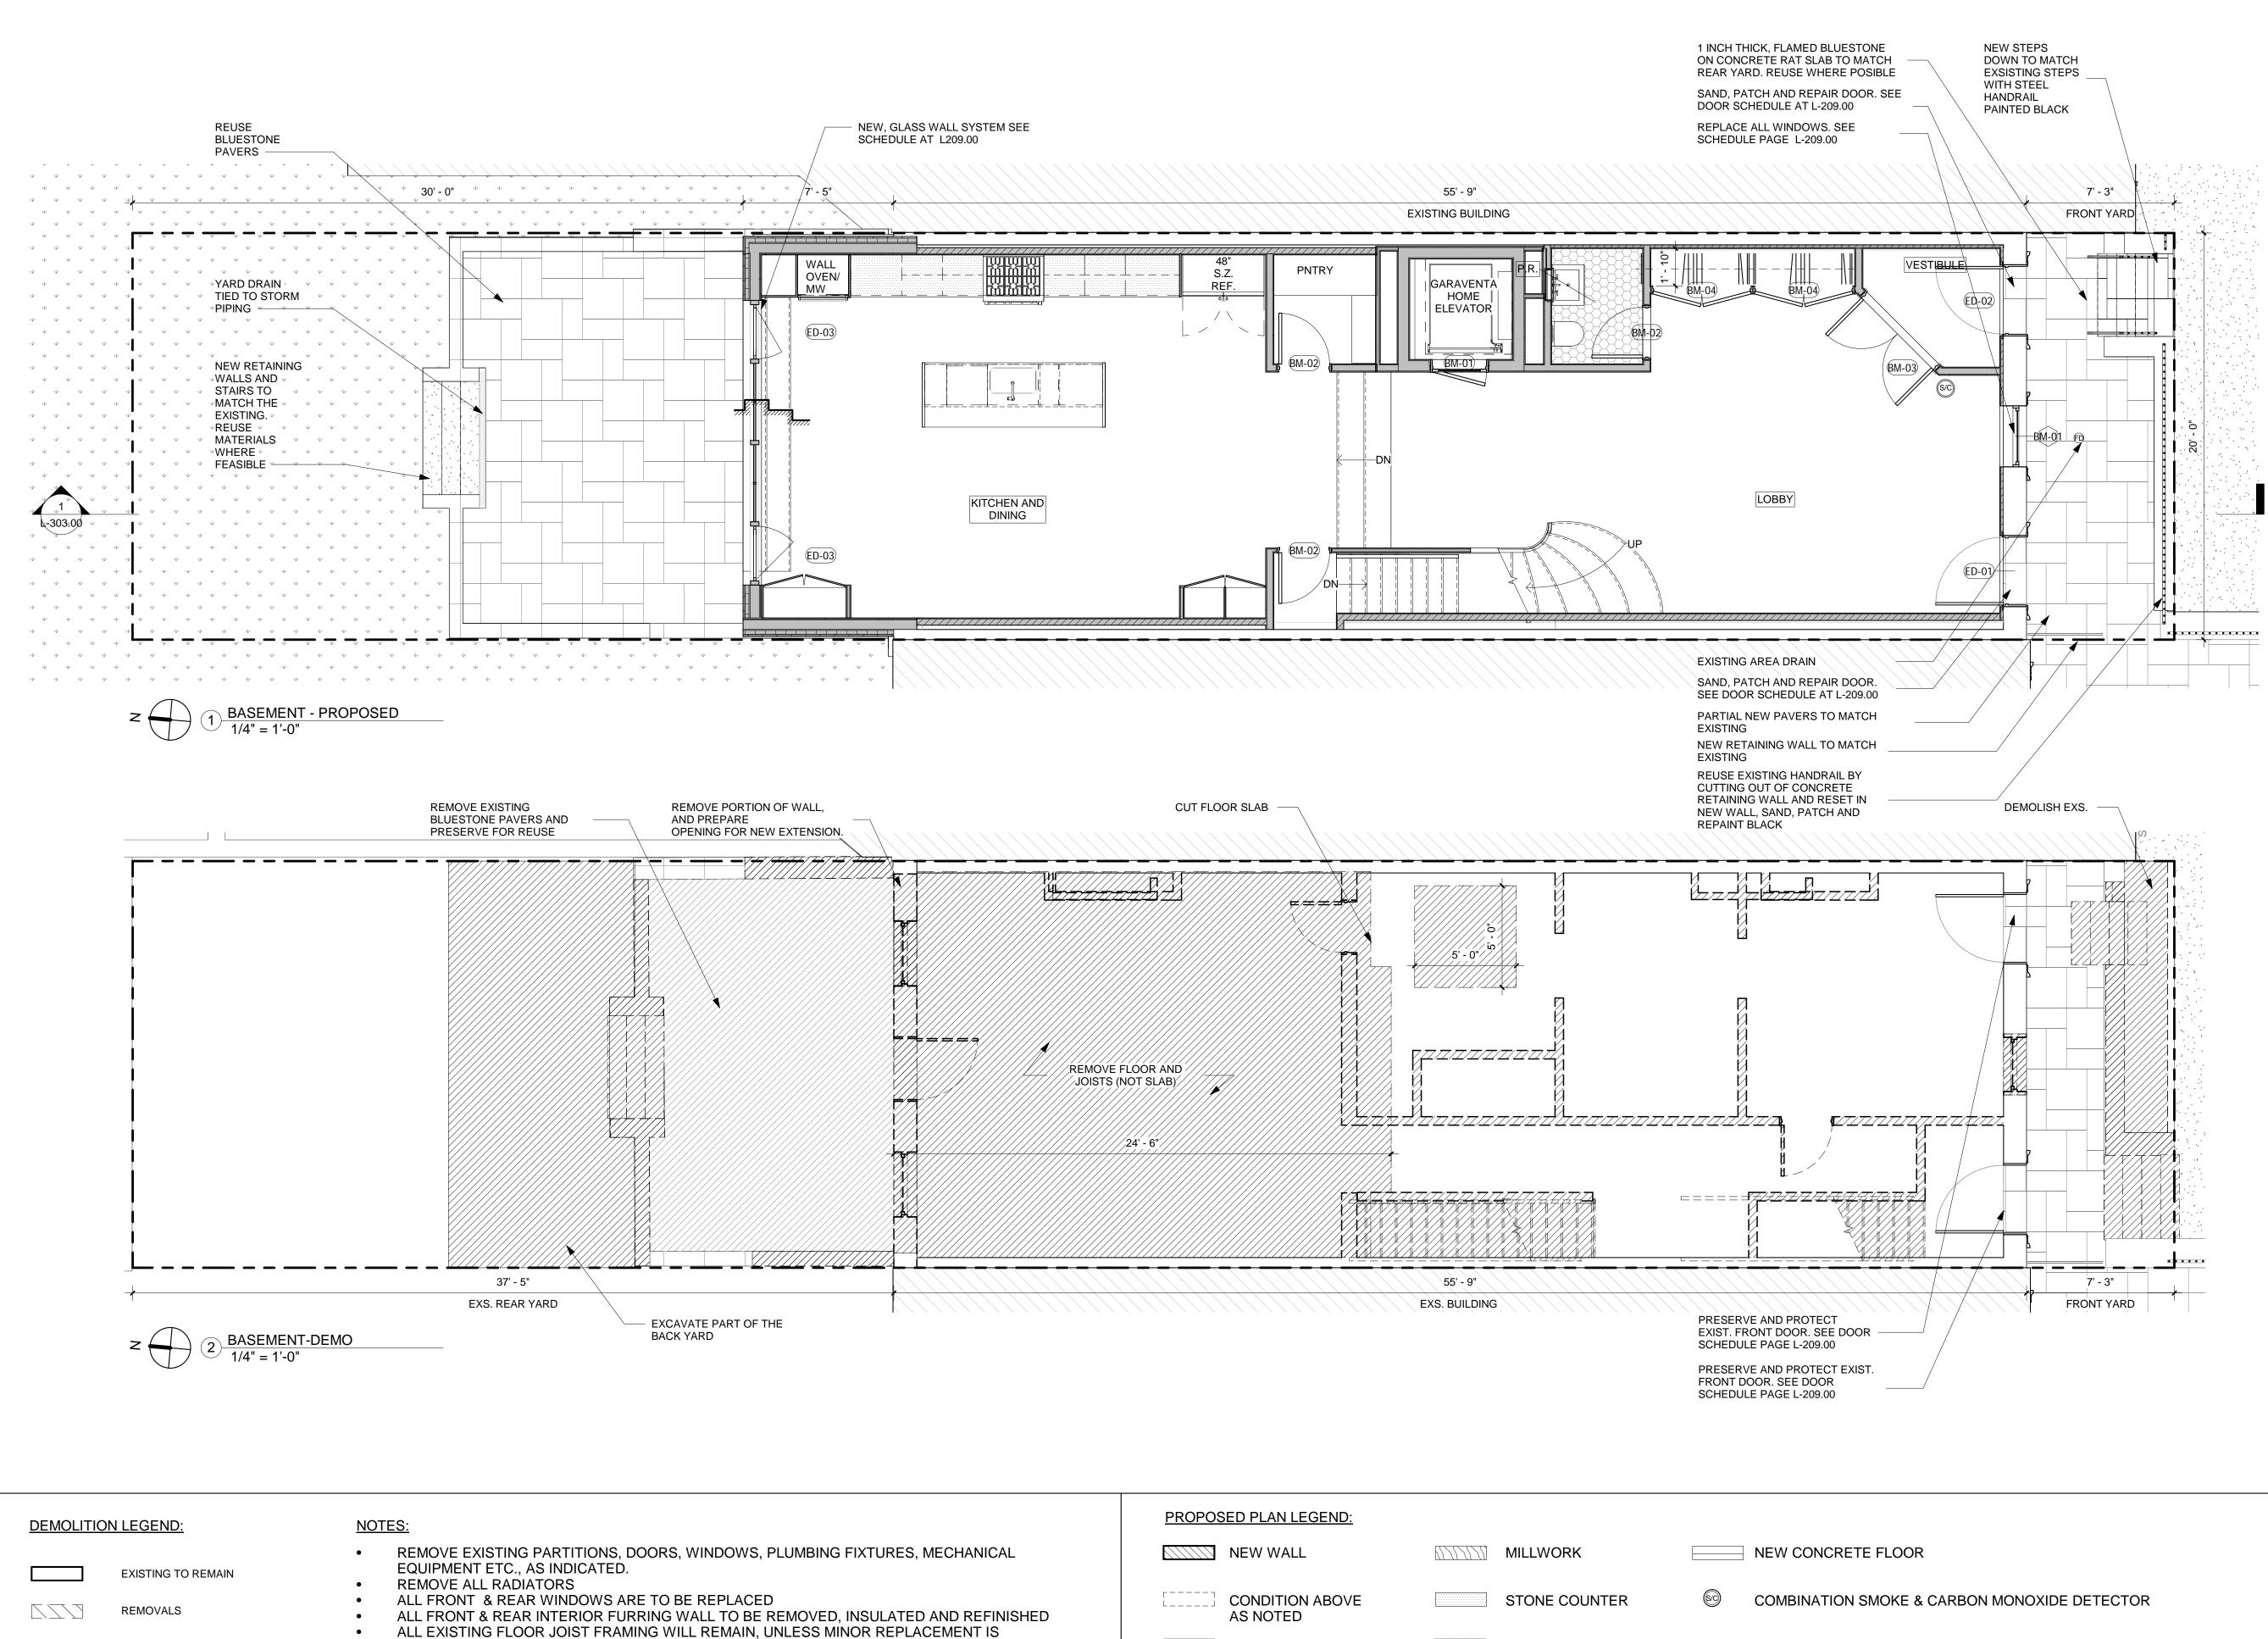
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DOB APPLICATION NO.: B01026912-I1

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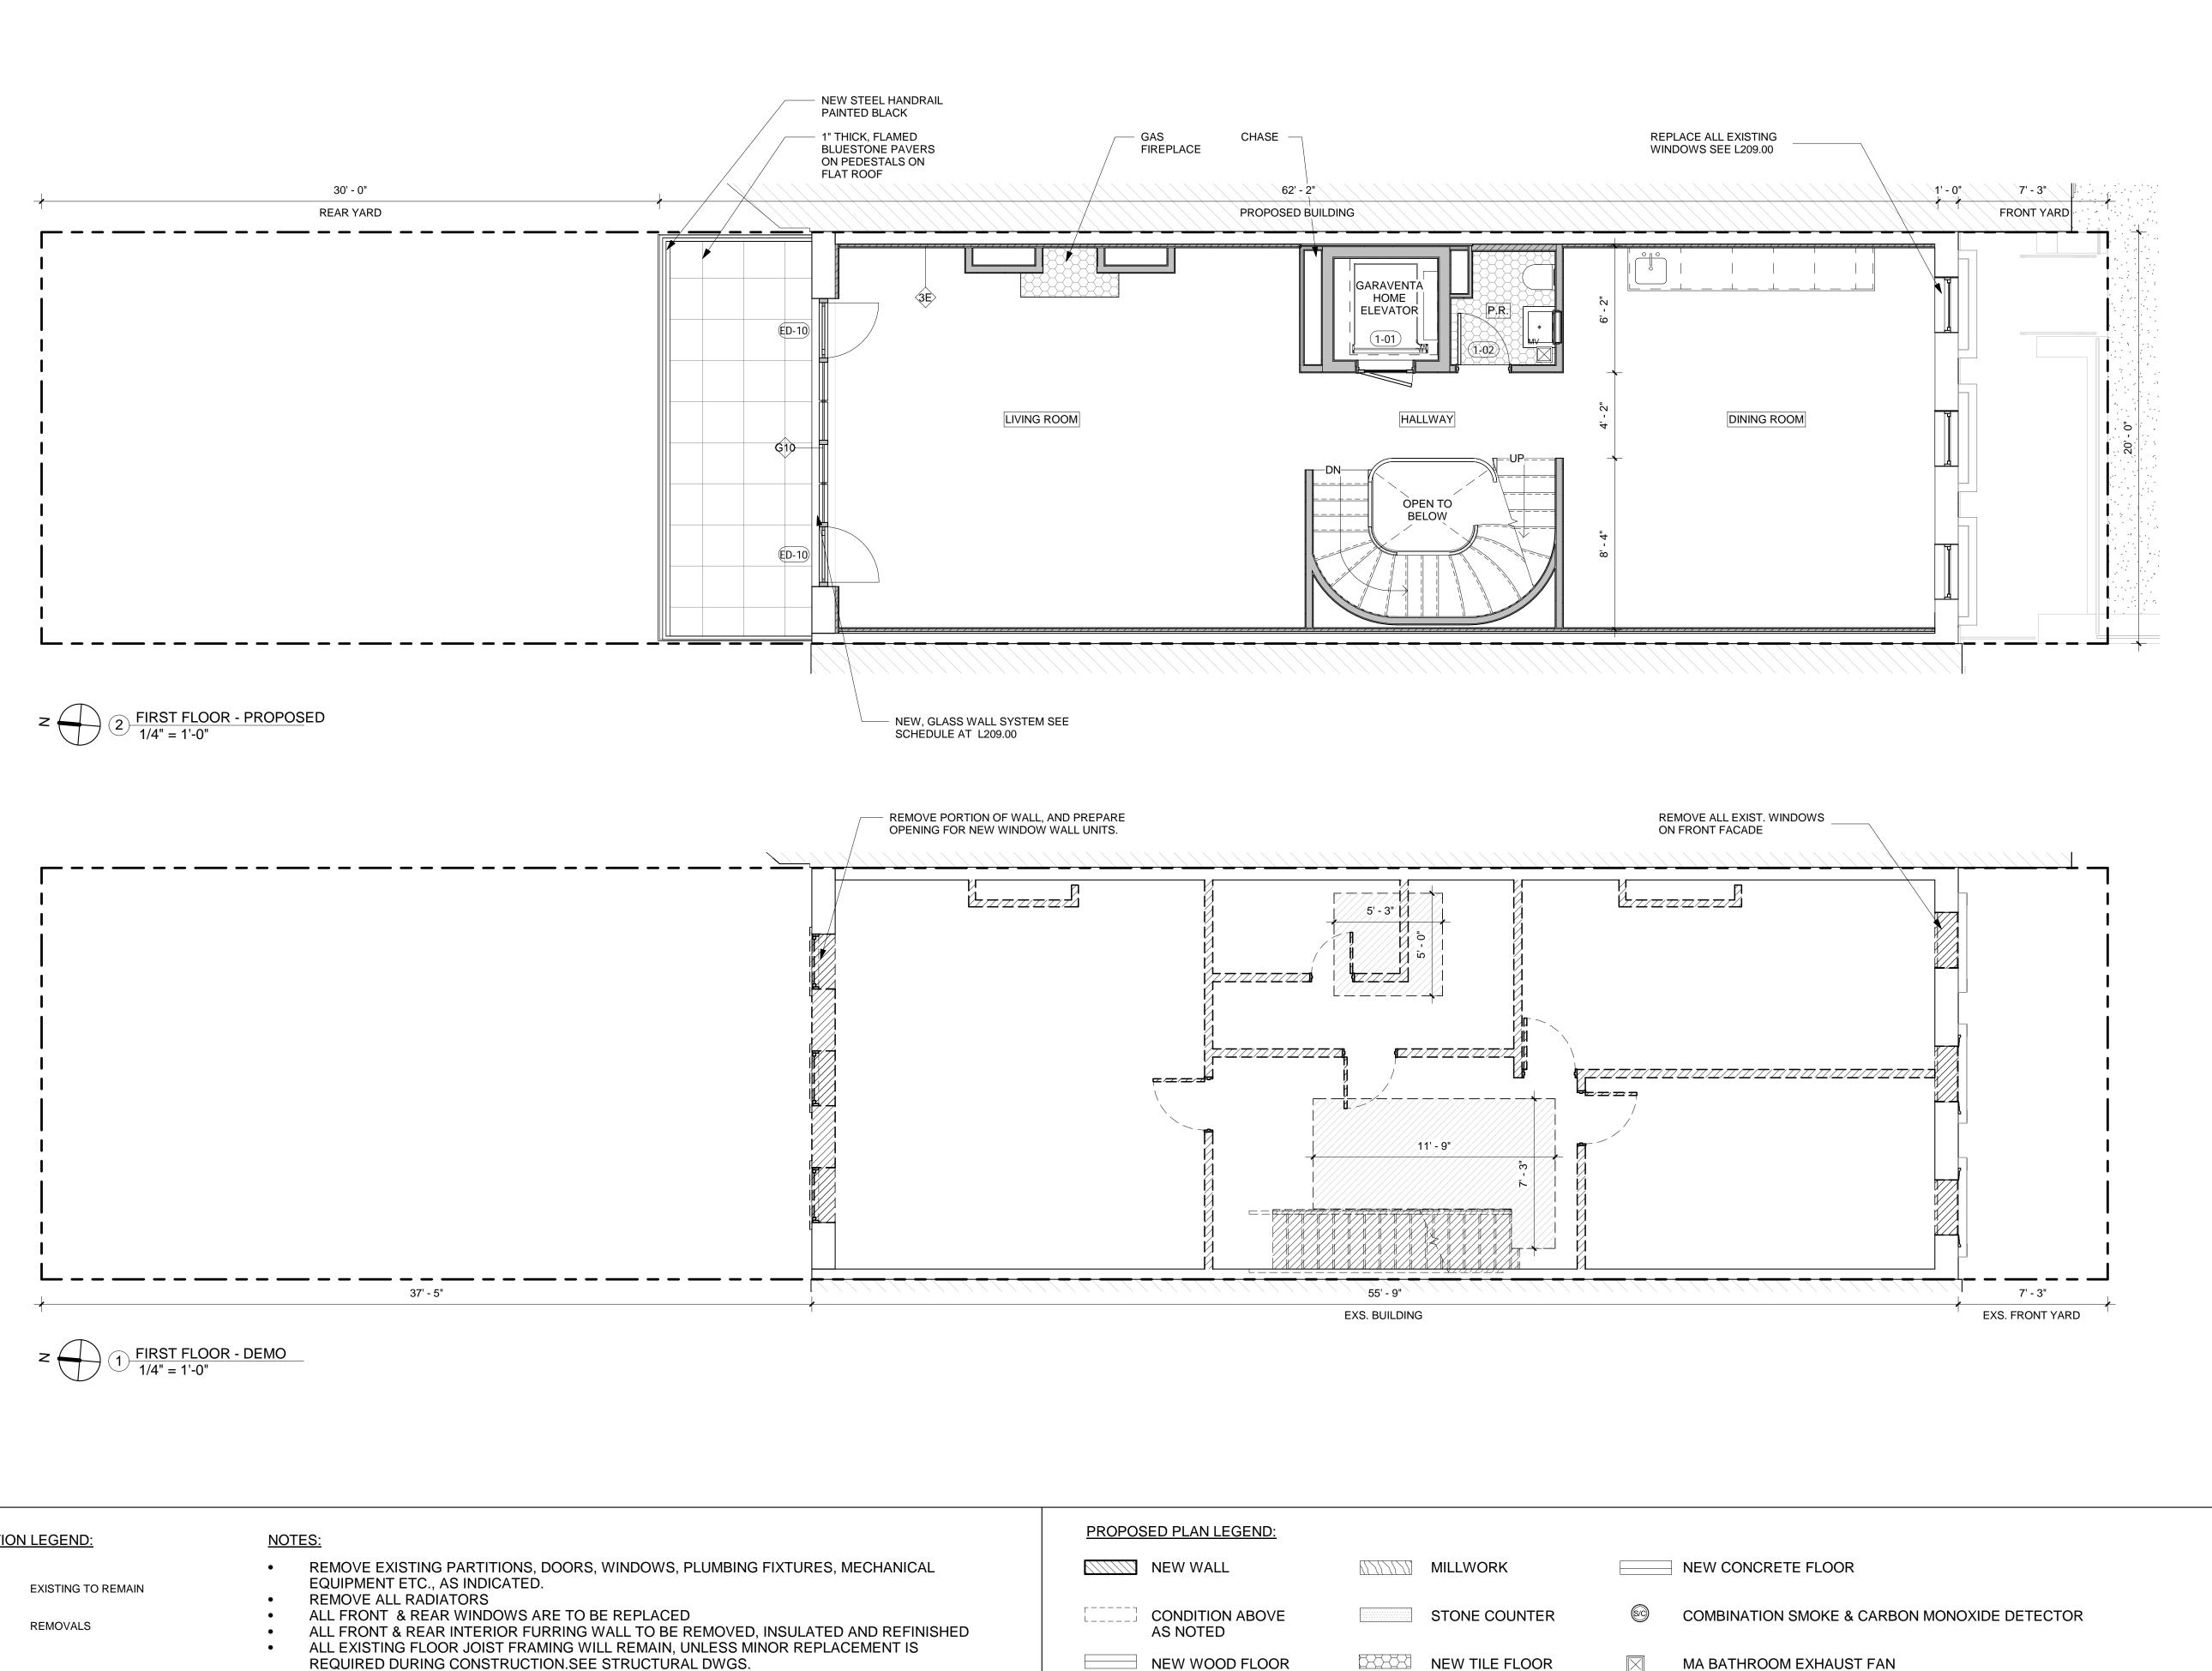
DATE	REVISION

PROJECT

156 EAST 71 STREET


TITLE **DEMOLITION & PROPOSED** PLAN - BASEMENT

BLOCK	1405
LOT	47
DATE	07/31/24
JOB NO.:	0147
SCALE:	AS NOTED
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L-10)2.00
	LOT DATE JOB NO.: SCALE: DRAWING NO.



DEMOLITION LEGEND:

 $\Box \Box \Box$

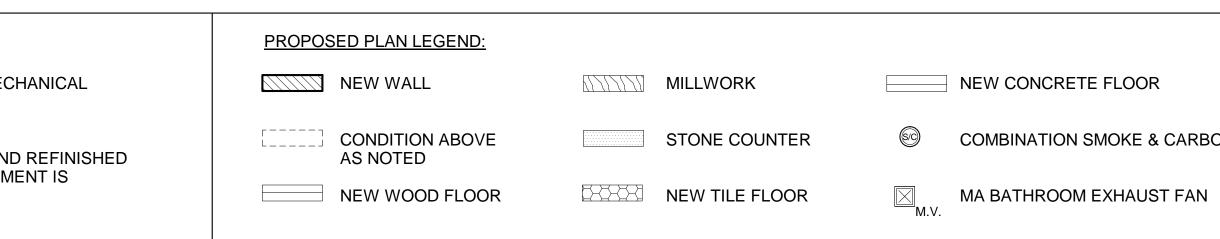

156 E 71 ST

156 EAST 71 STREET

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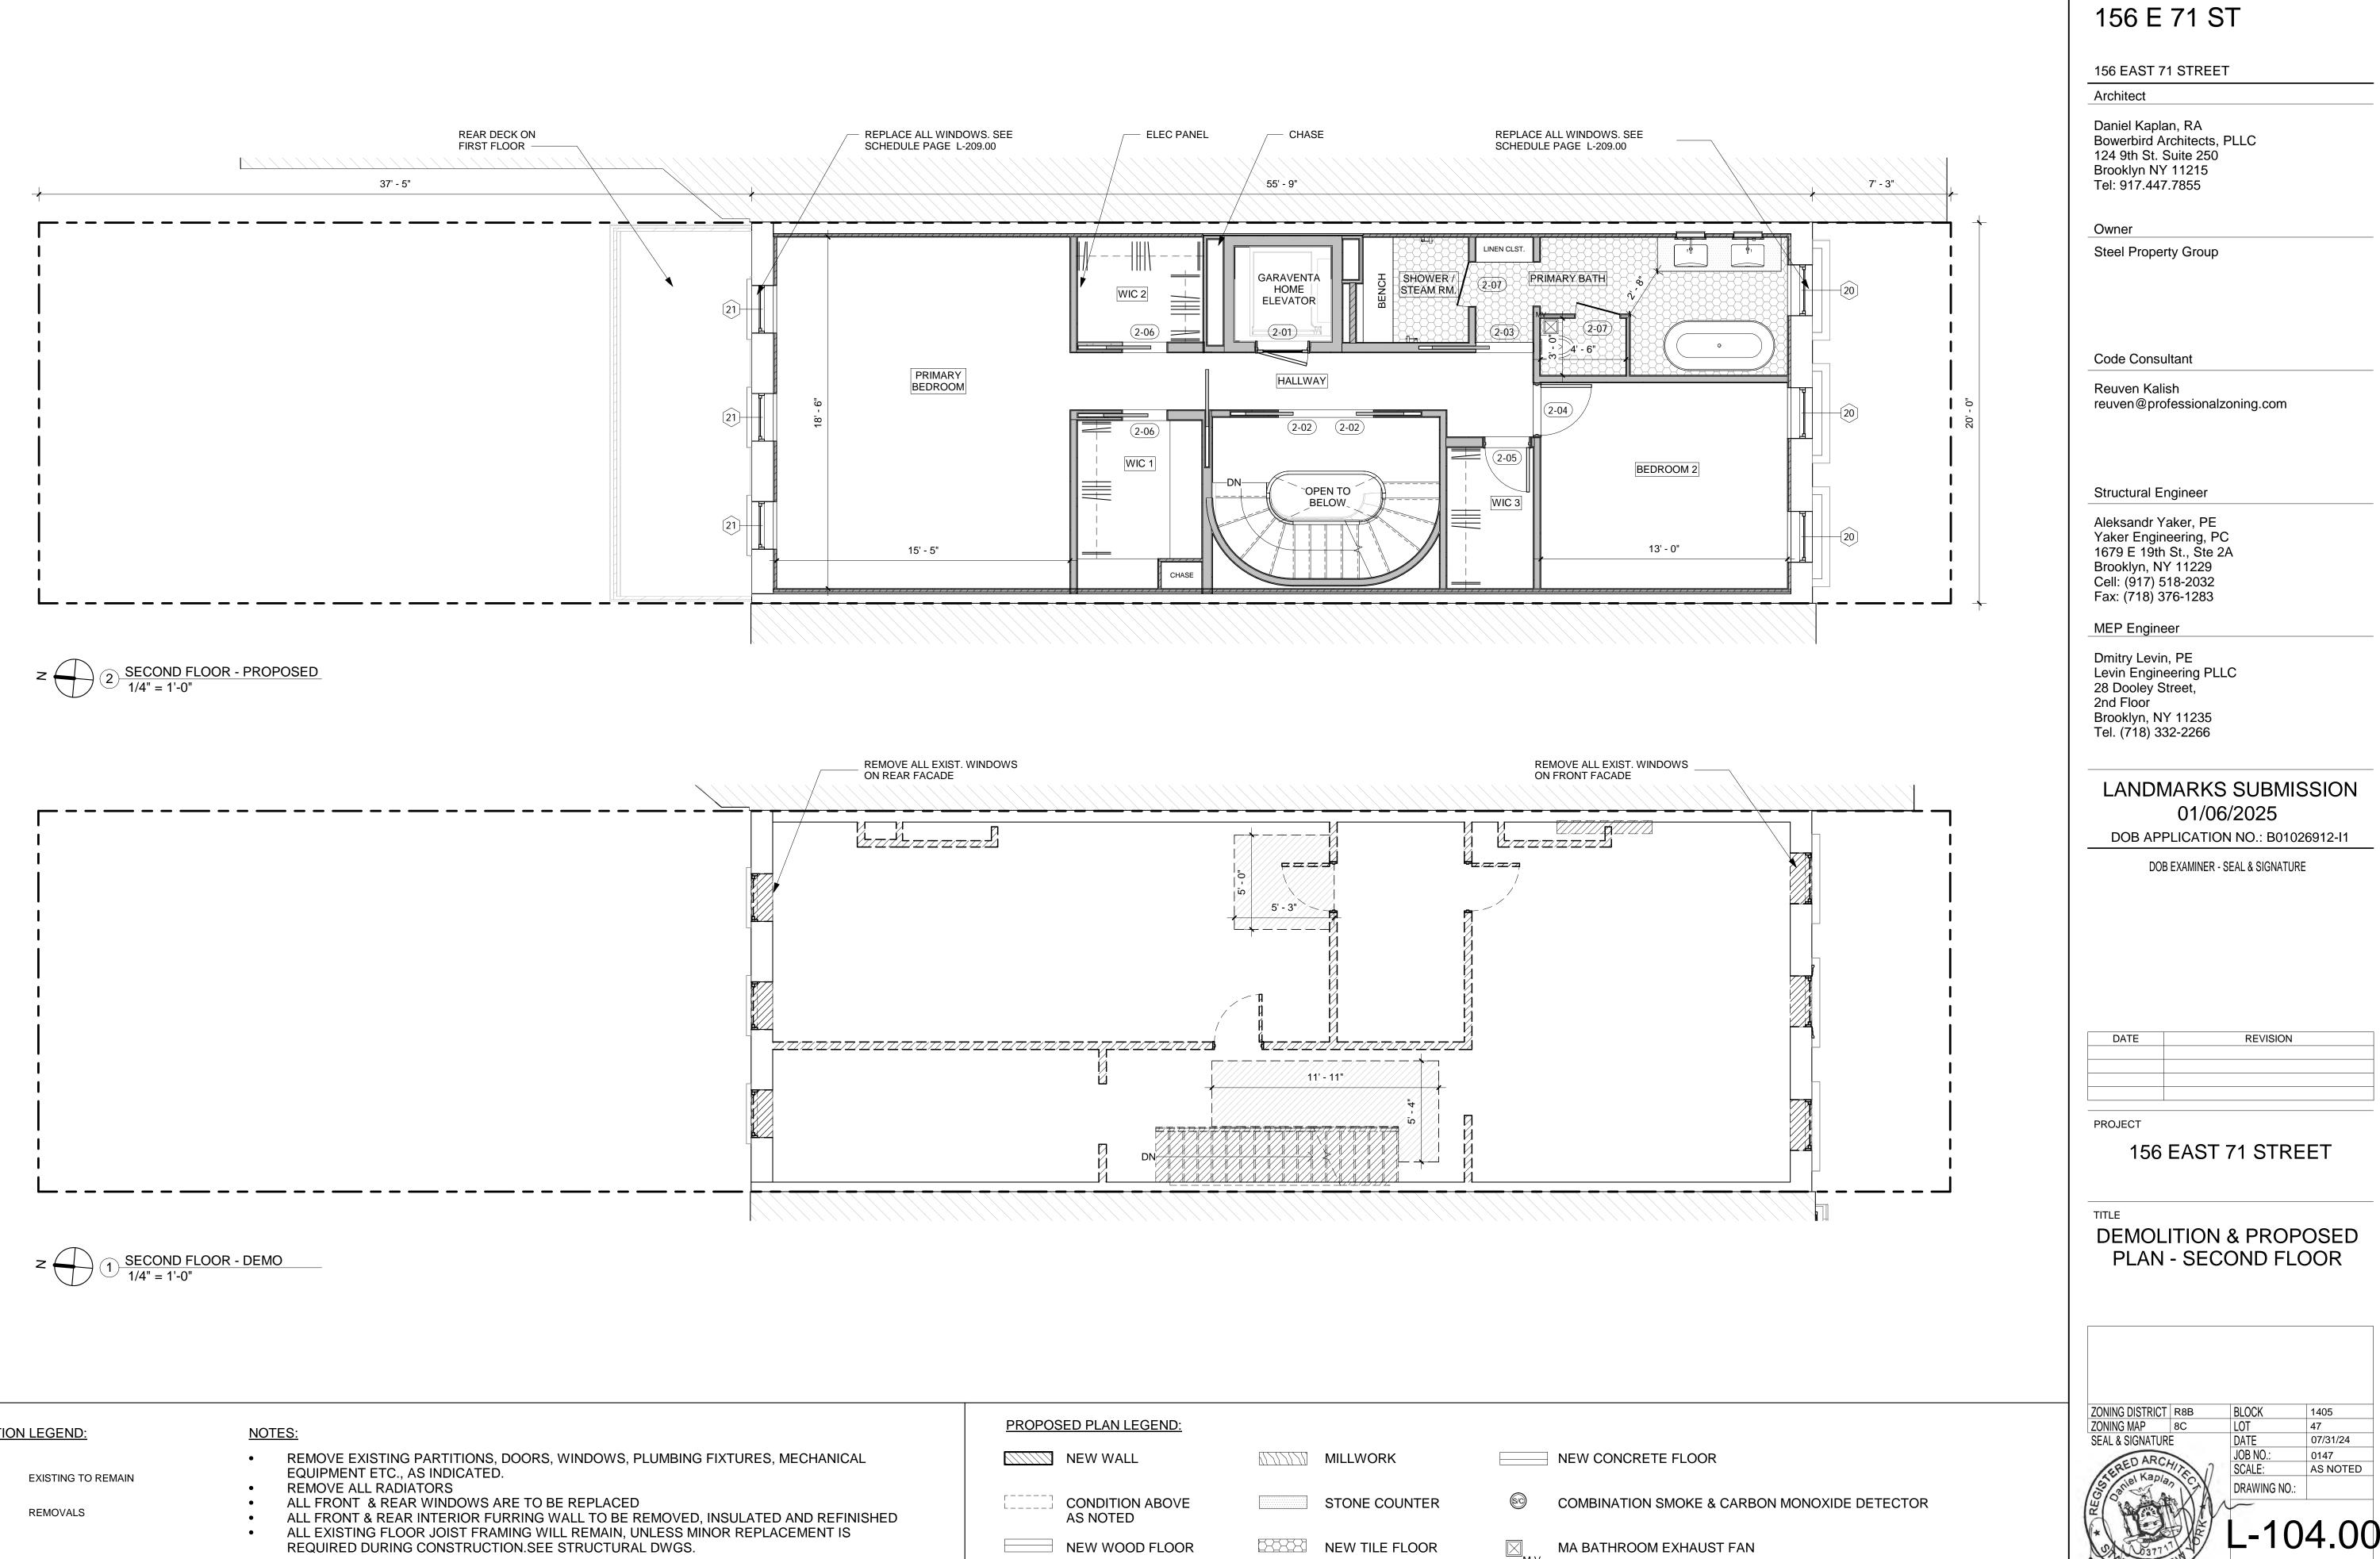
DATE	REVISION

PROJECT

156 EAST 71 STREET


TITLE **DEMOLITION & PROPOSED** PLAN - FIRST FLOOR


ZONING DISTRICT	R8B	BLOCK	1405
ZONING MAP	8C	LOT	47
SEAL & SIGNATURE		DATE	07/31/24
DARC		JOB NO.:	0147
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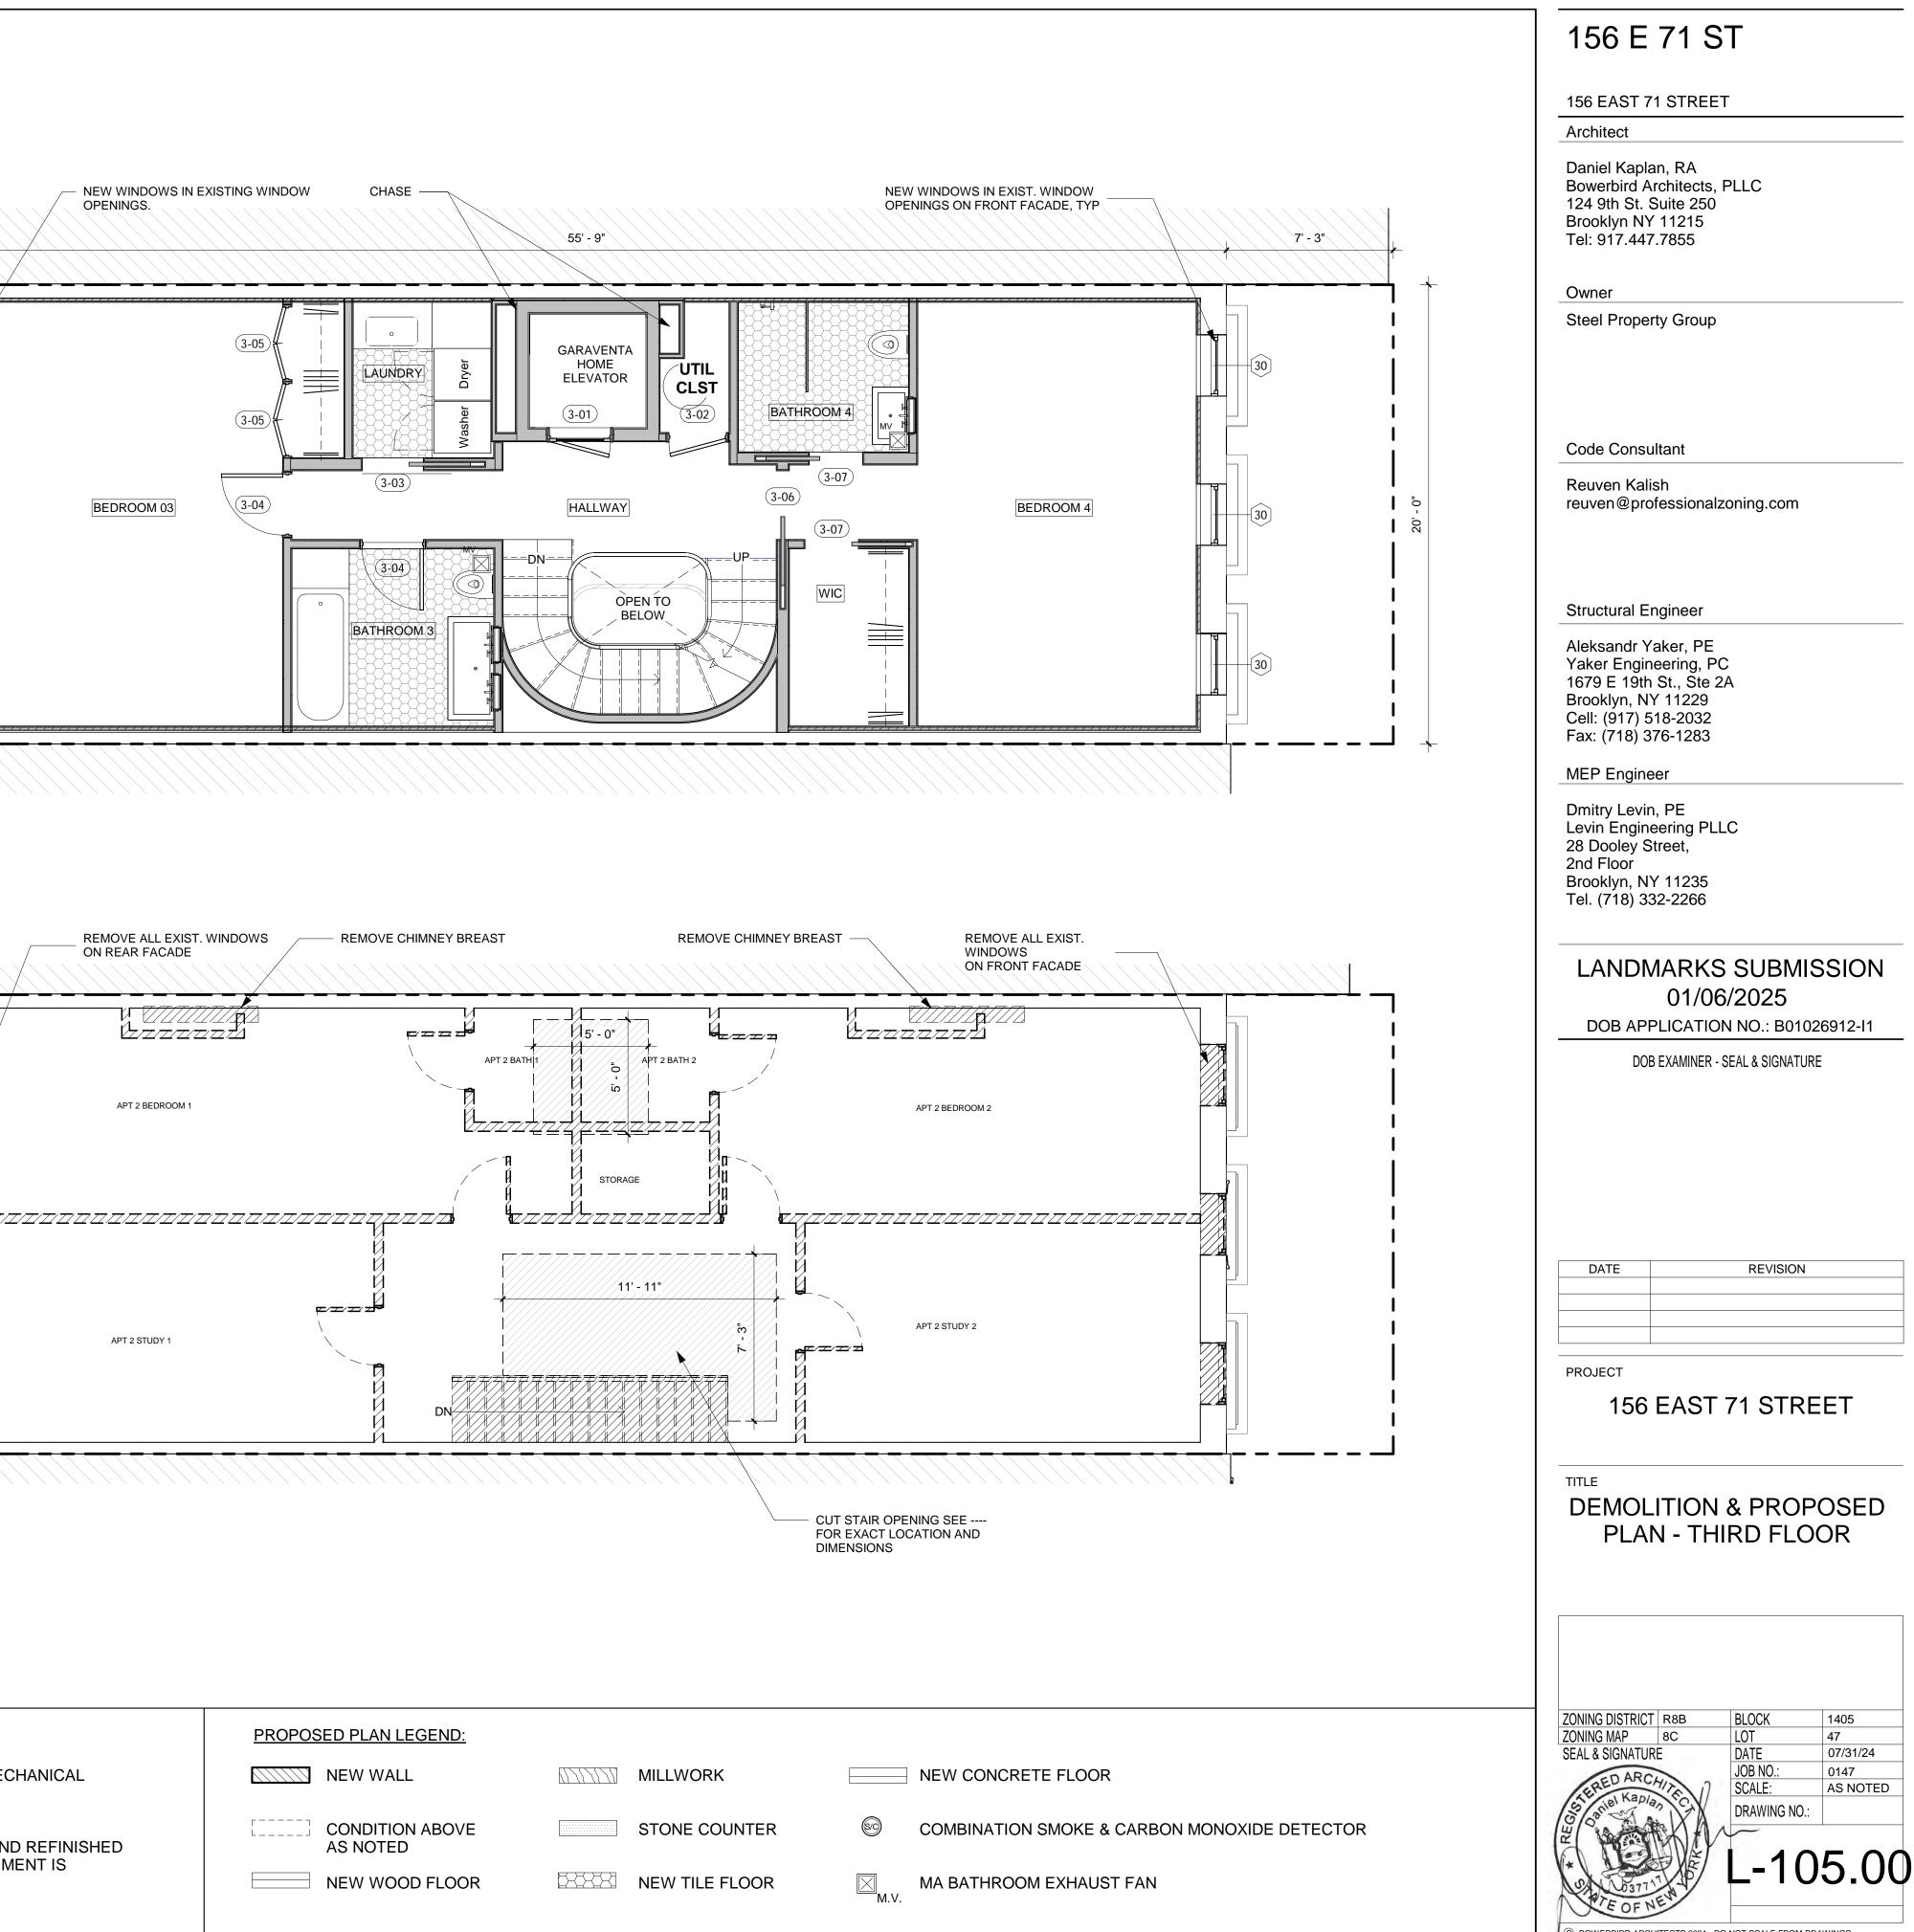
DEMOLITION LEGEND:


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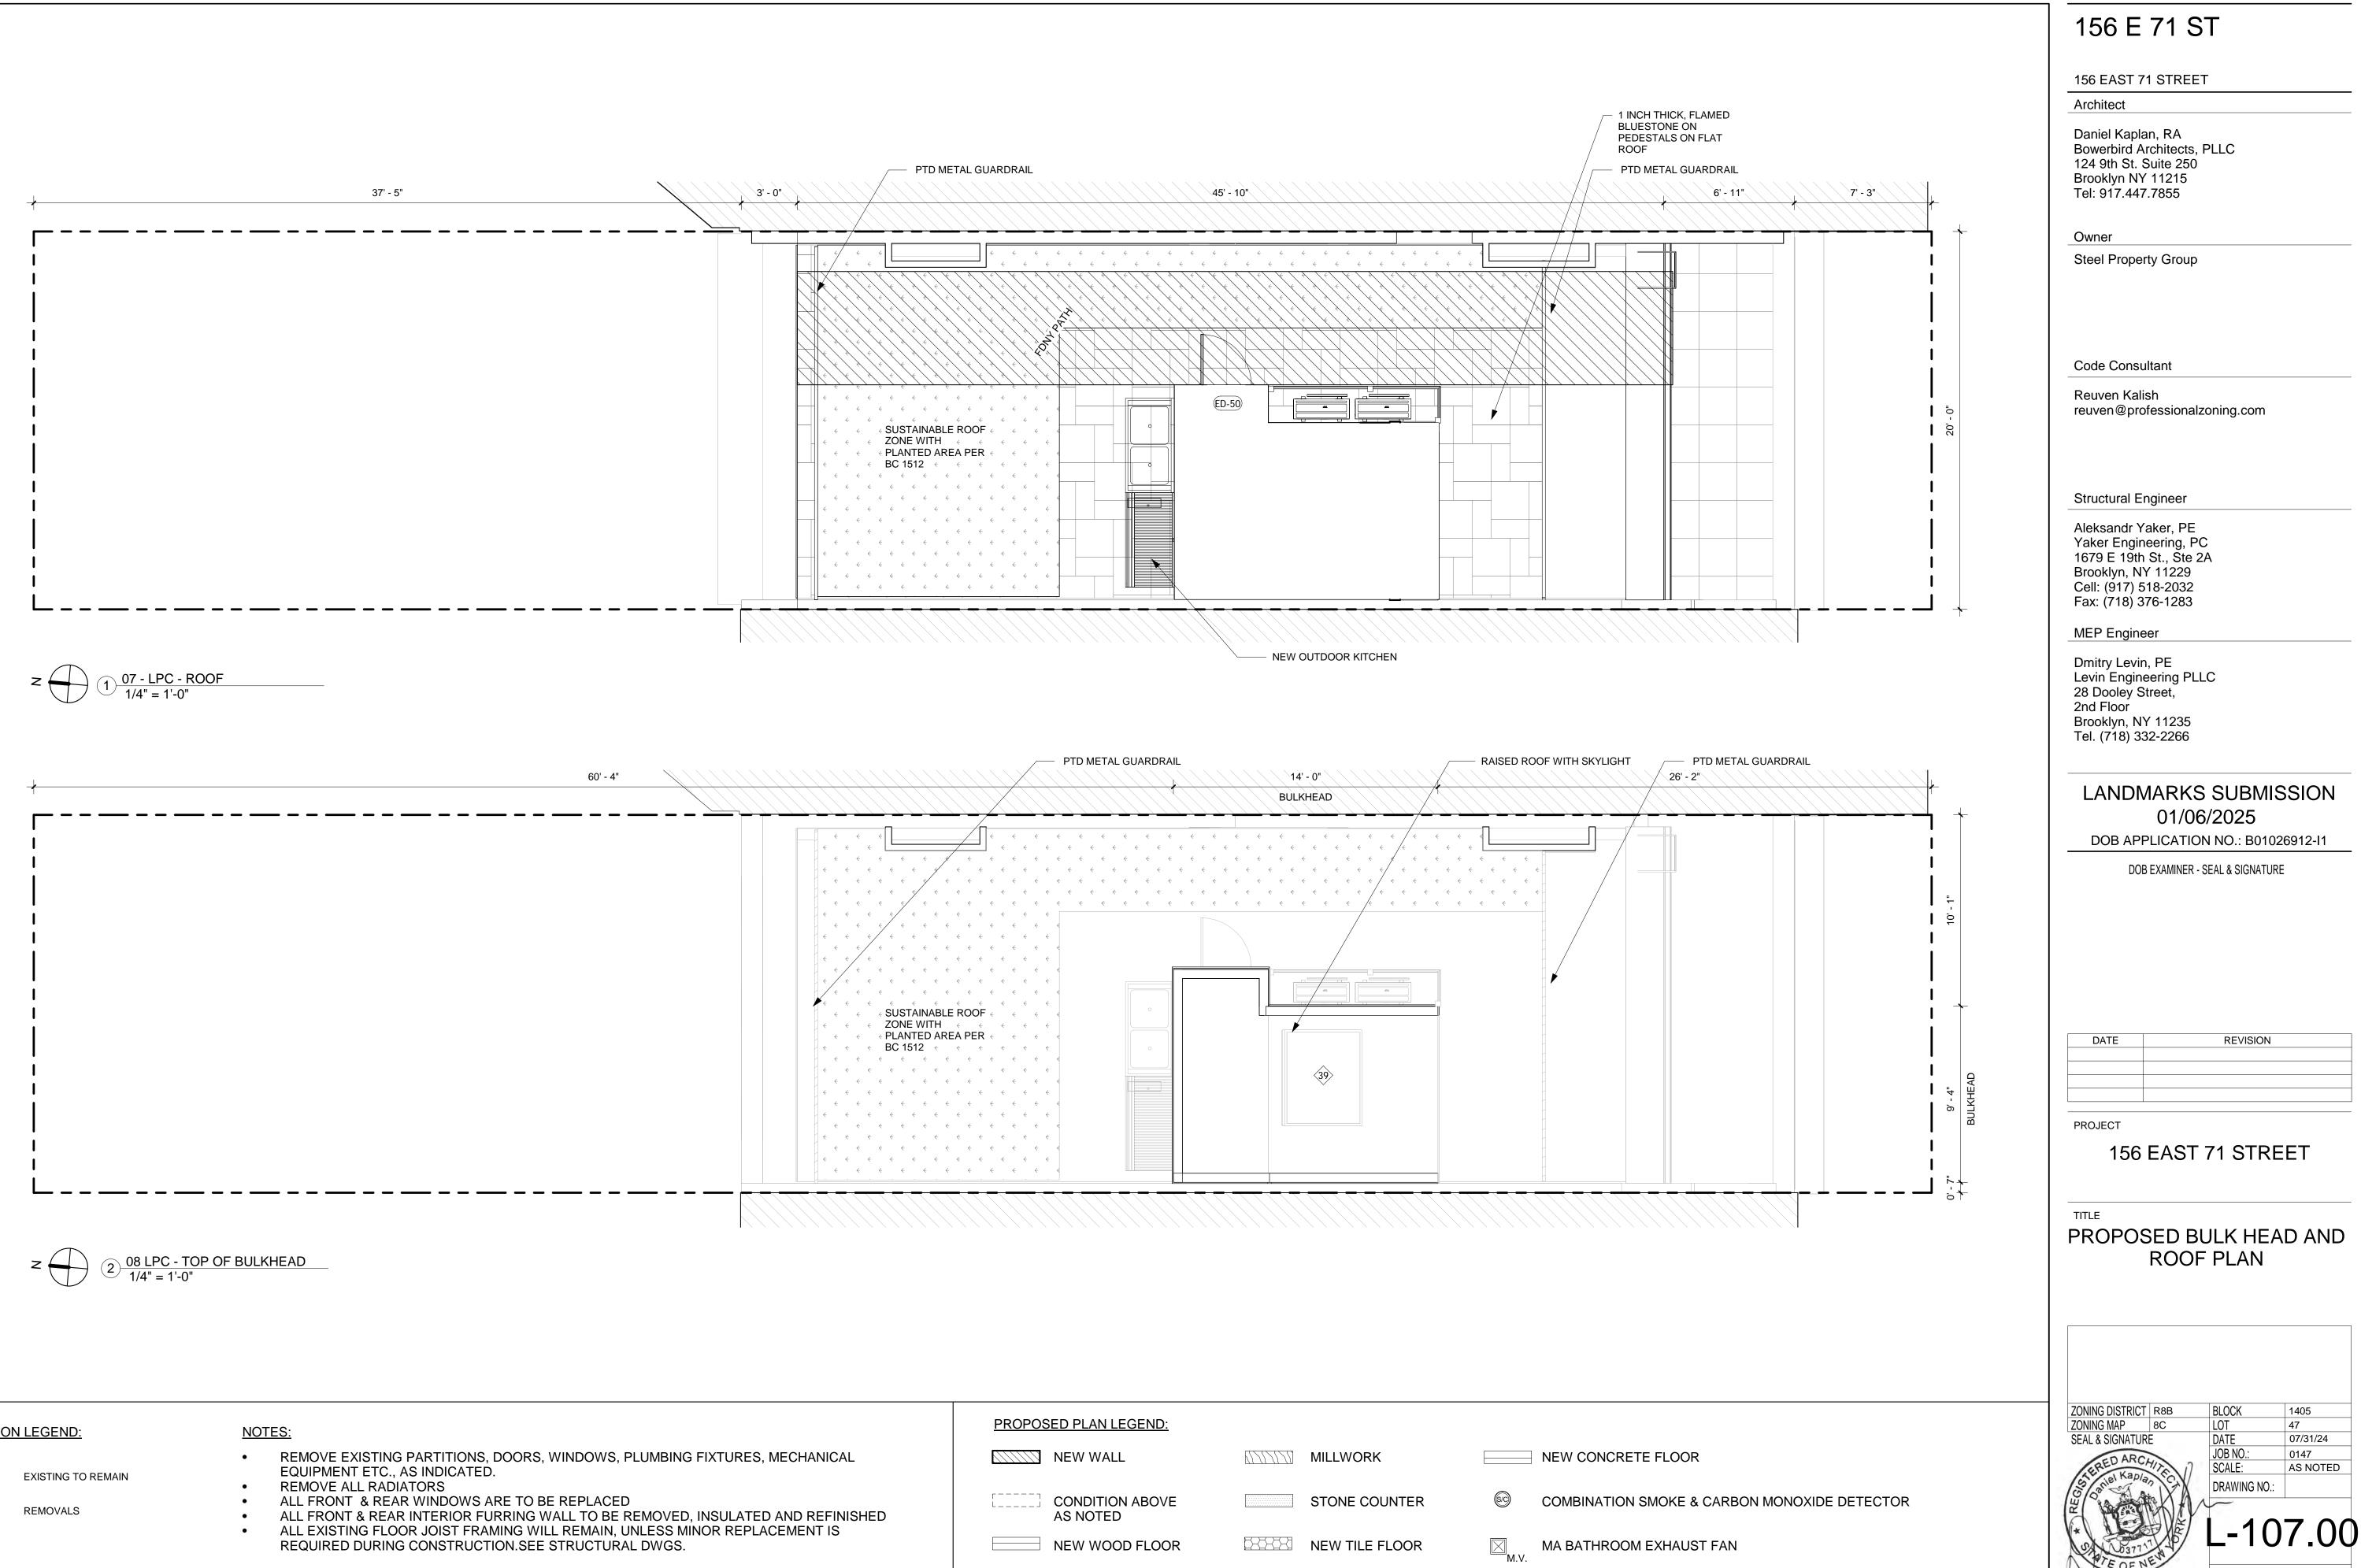
REQUIRED DURING CONSTRUCTION.SEE STRUCTURAL DWGS.



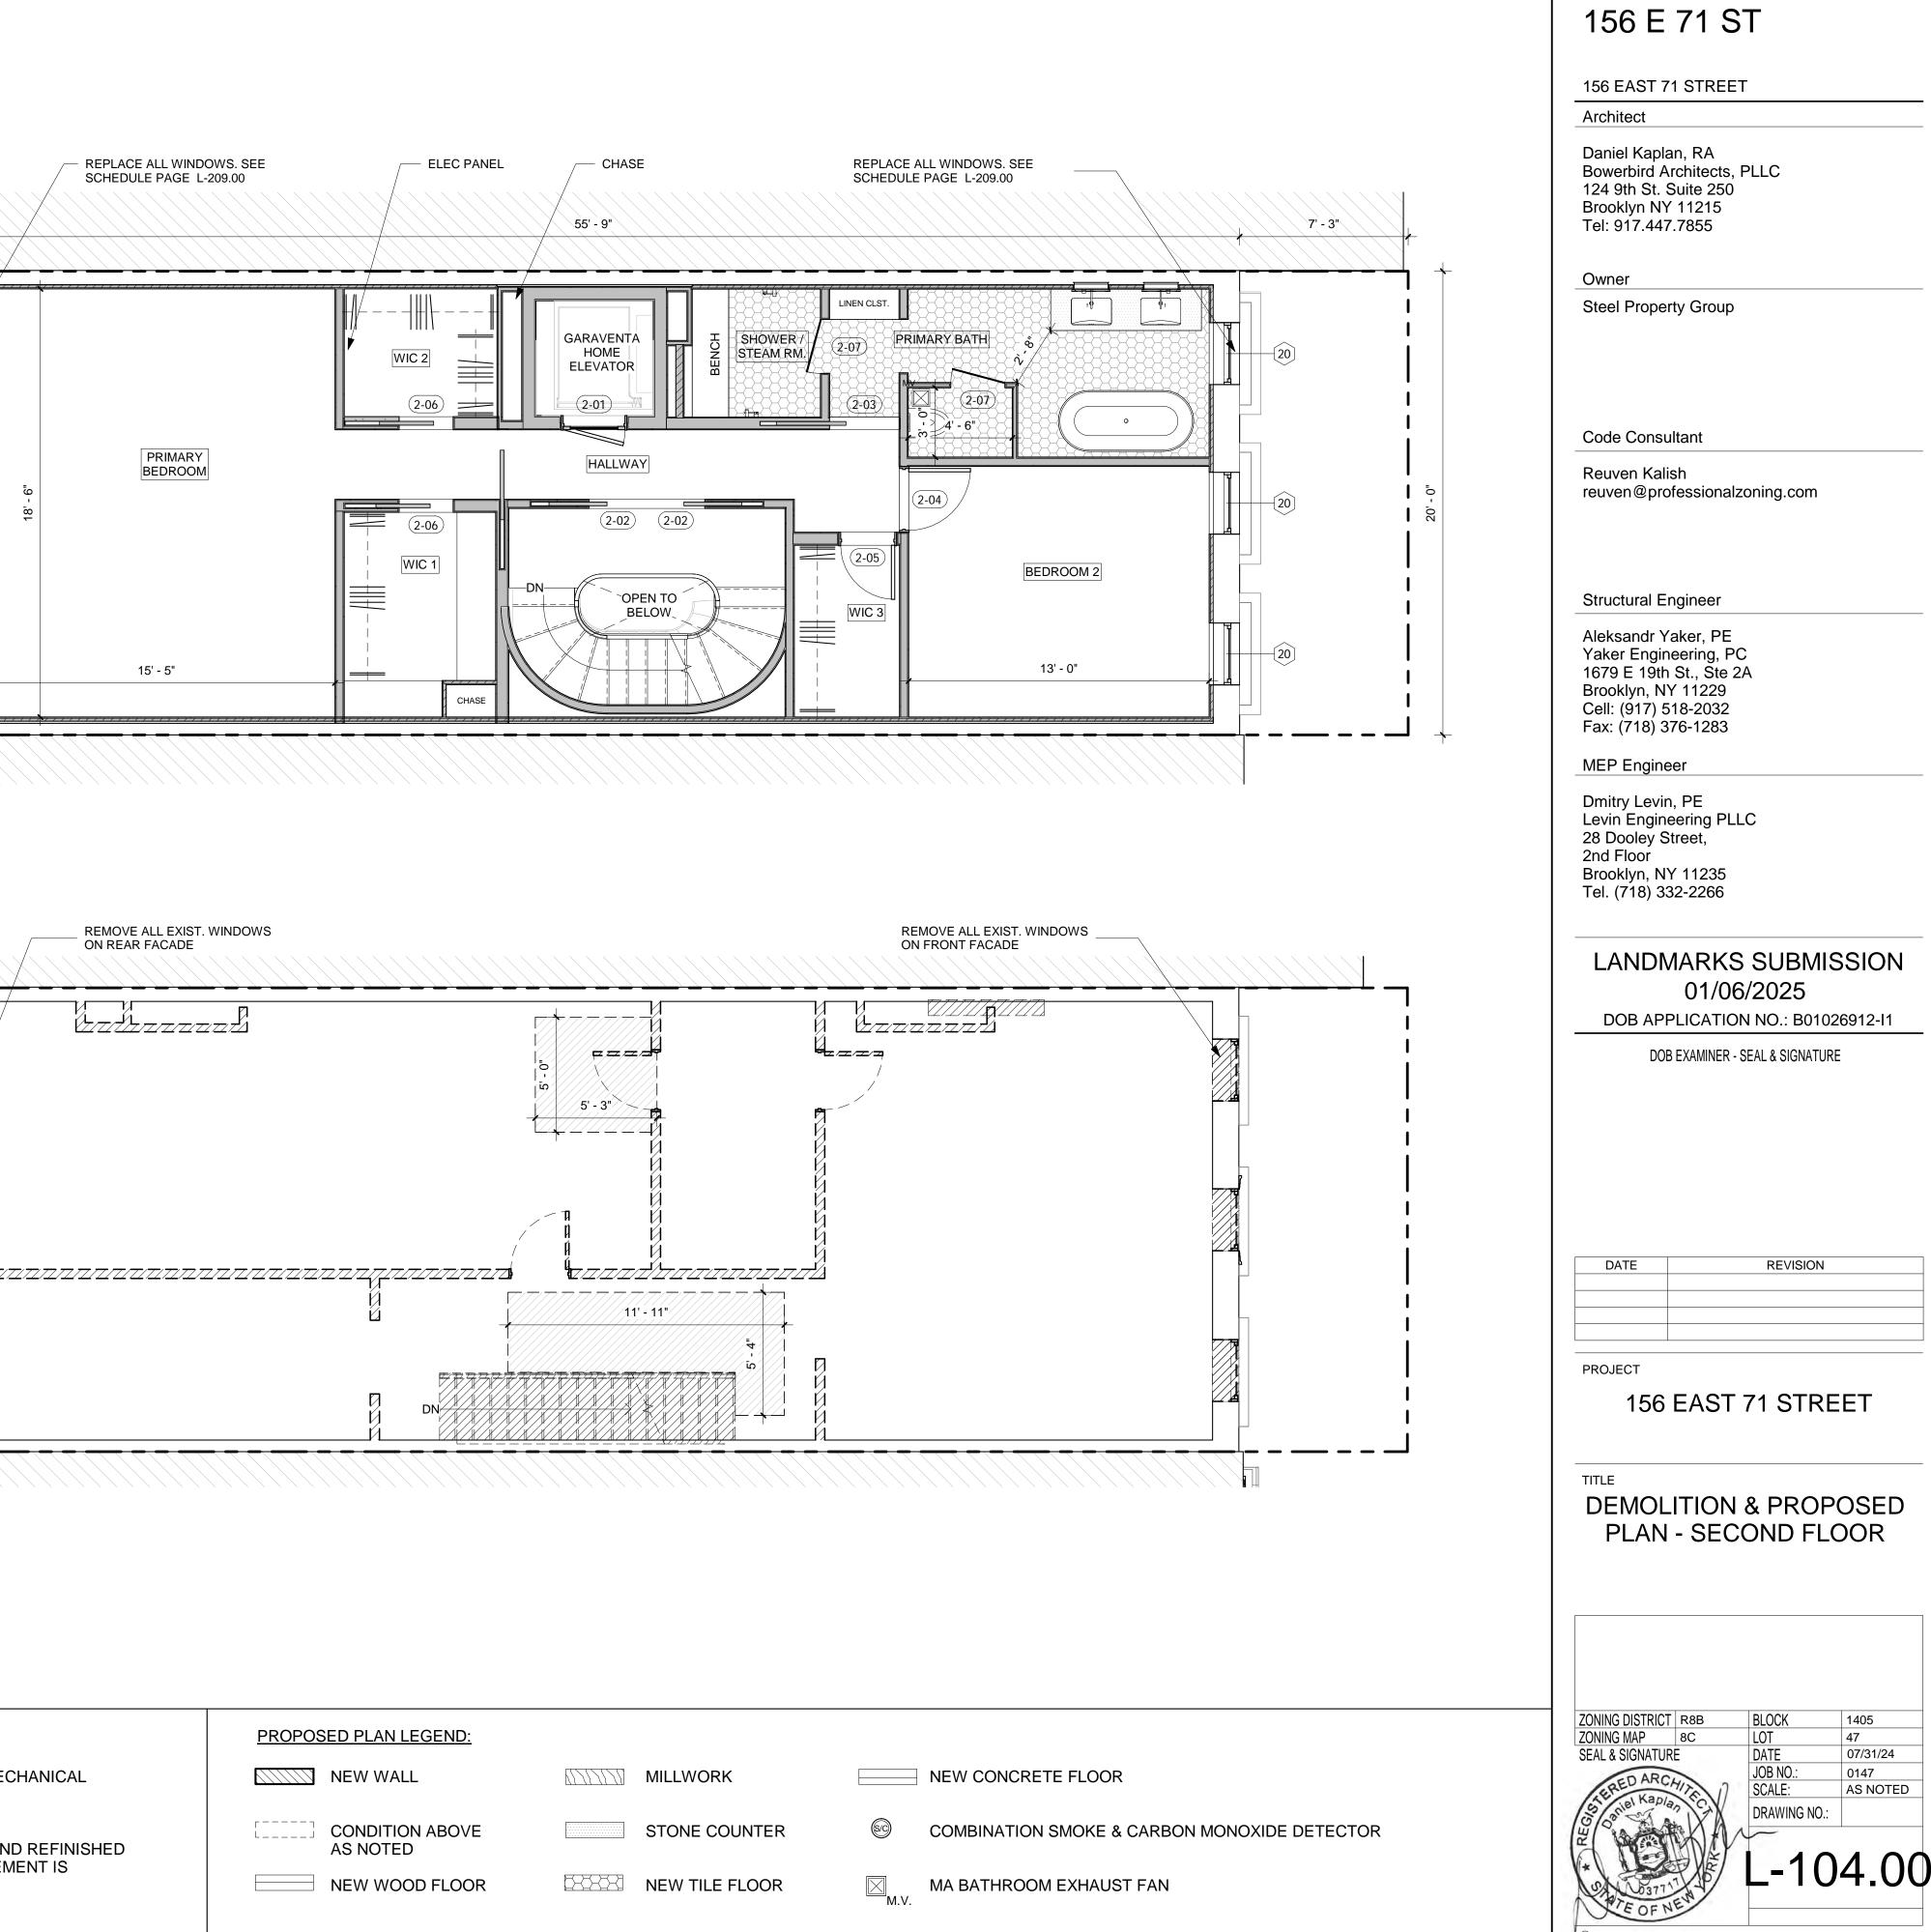

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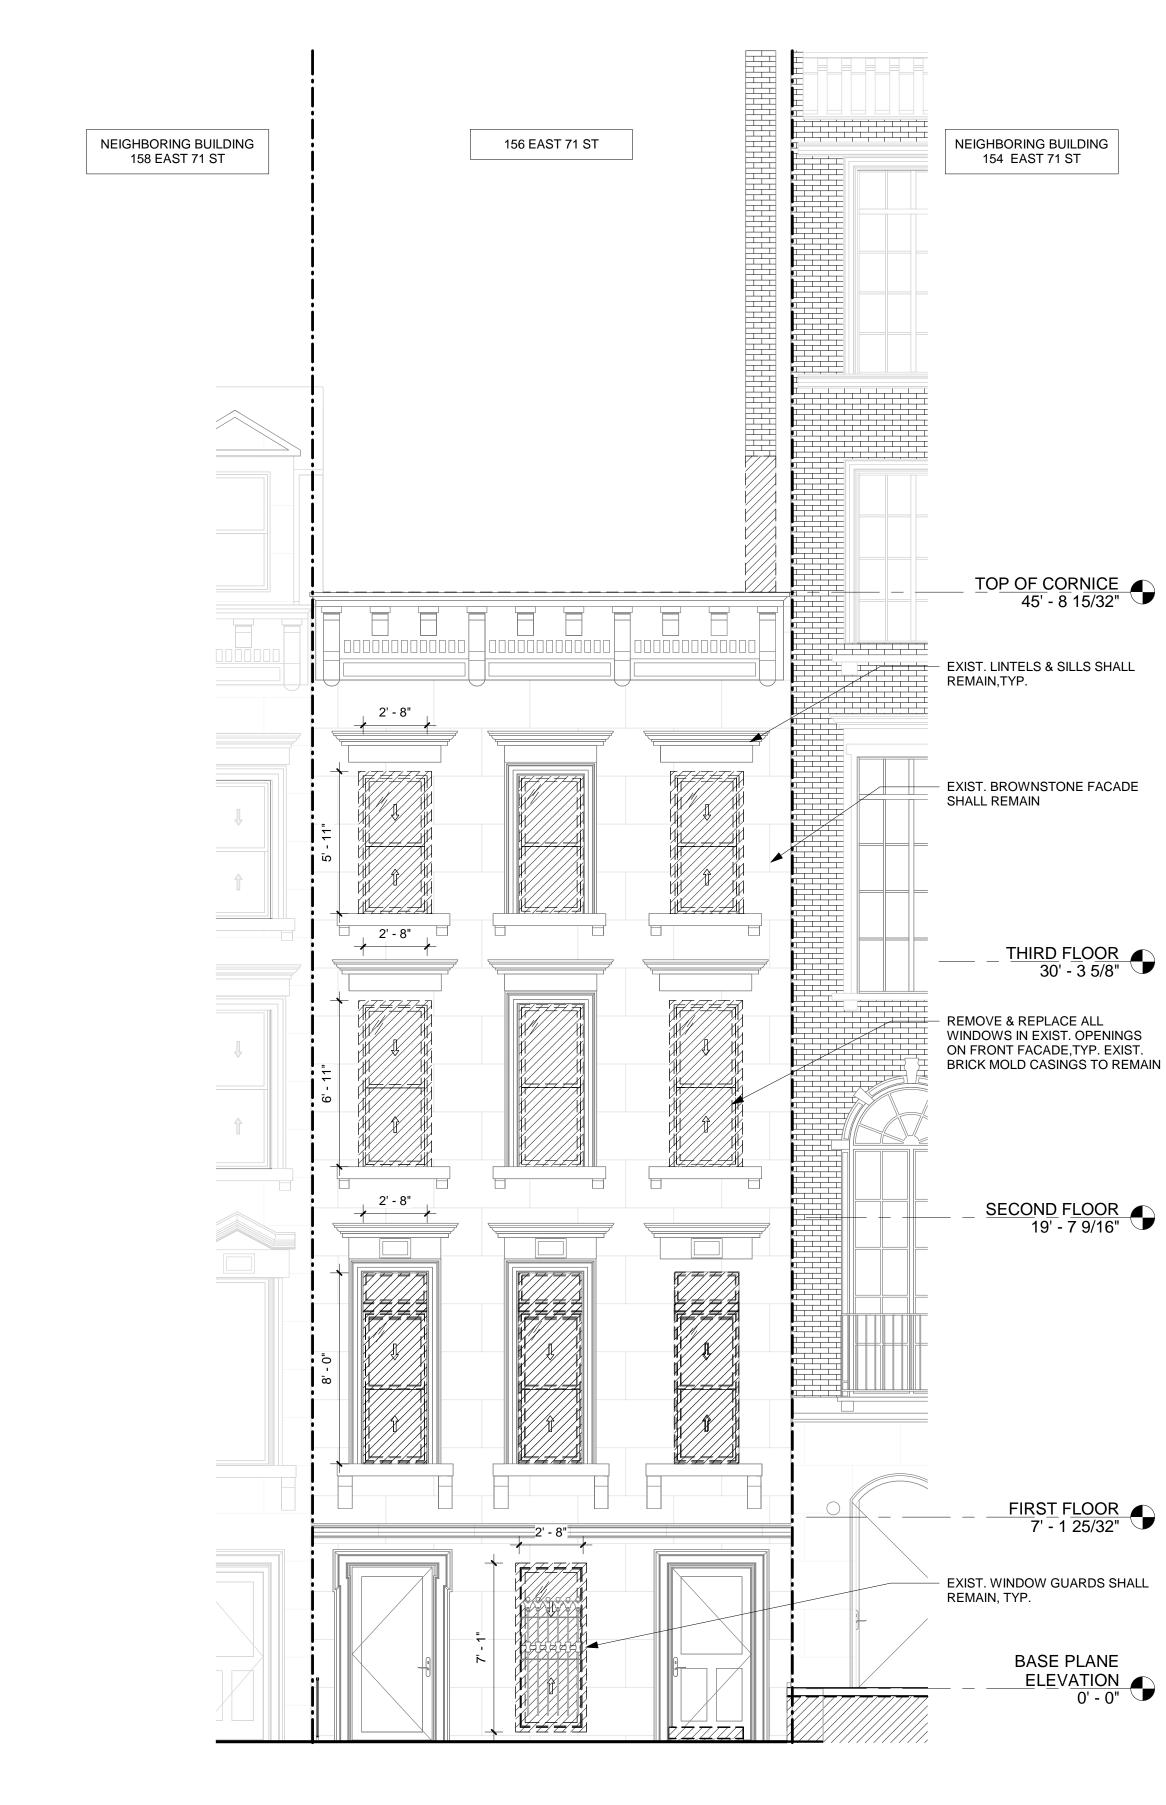
	PROPOSED PLAN LEGEND:		
ECHANICAL	NEW WALL	MILLWORK	NEW CONCRETE FLOOR
	CONDITION ABOVE	STONE COUNTER	COMBINATION SMOKE & CAP
MENT IS	NEW WOOD FLOOR		MA BATHROOM EXHAUST FA

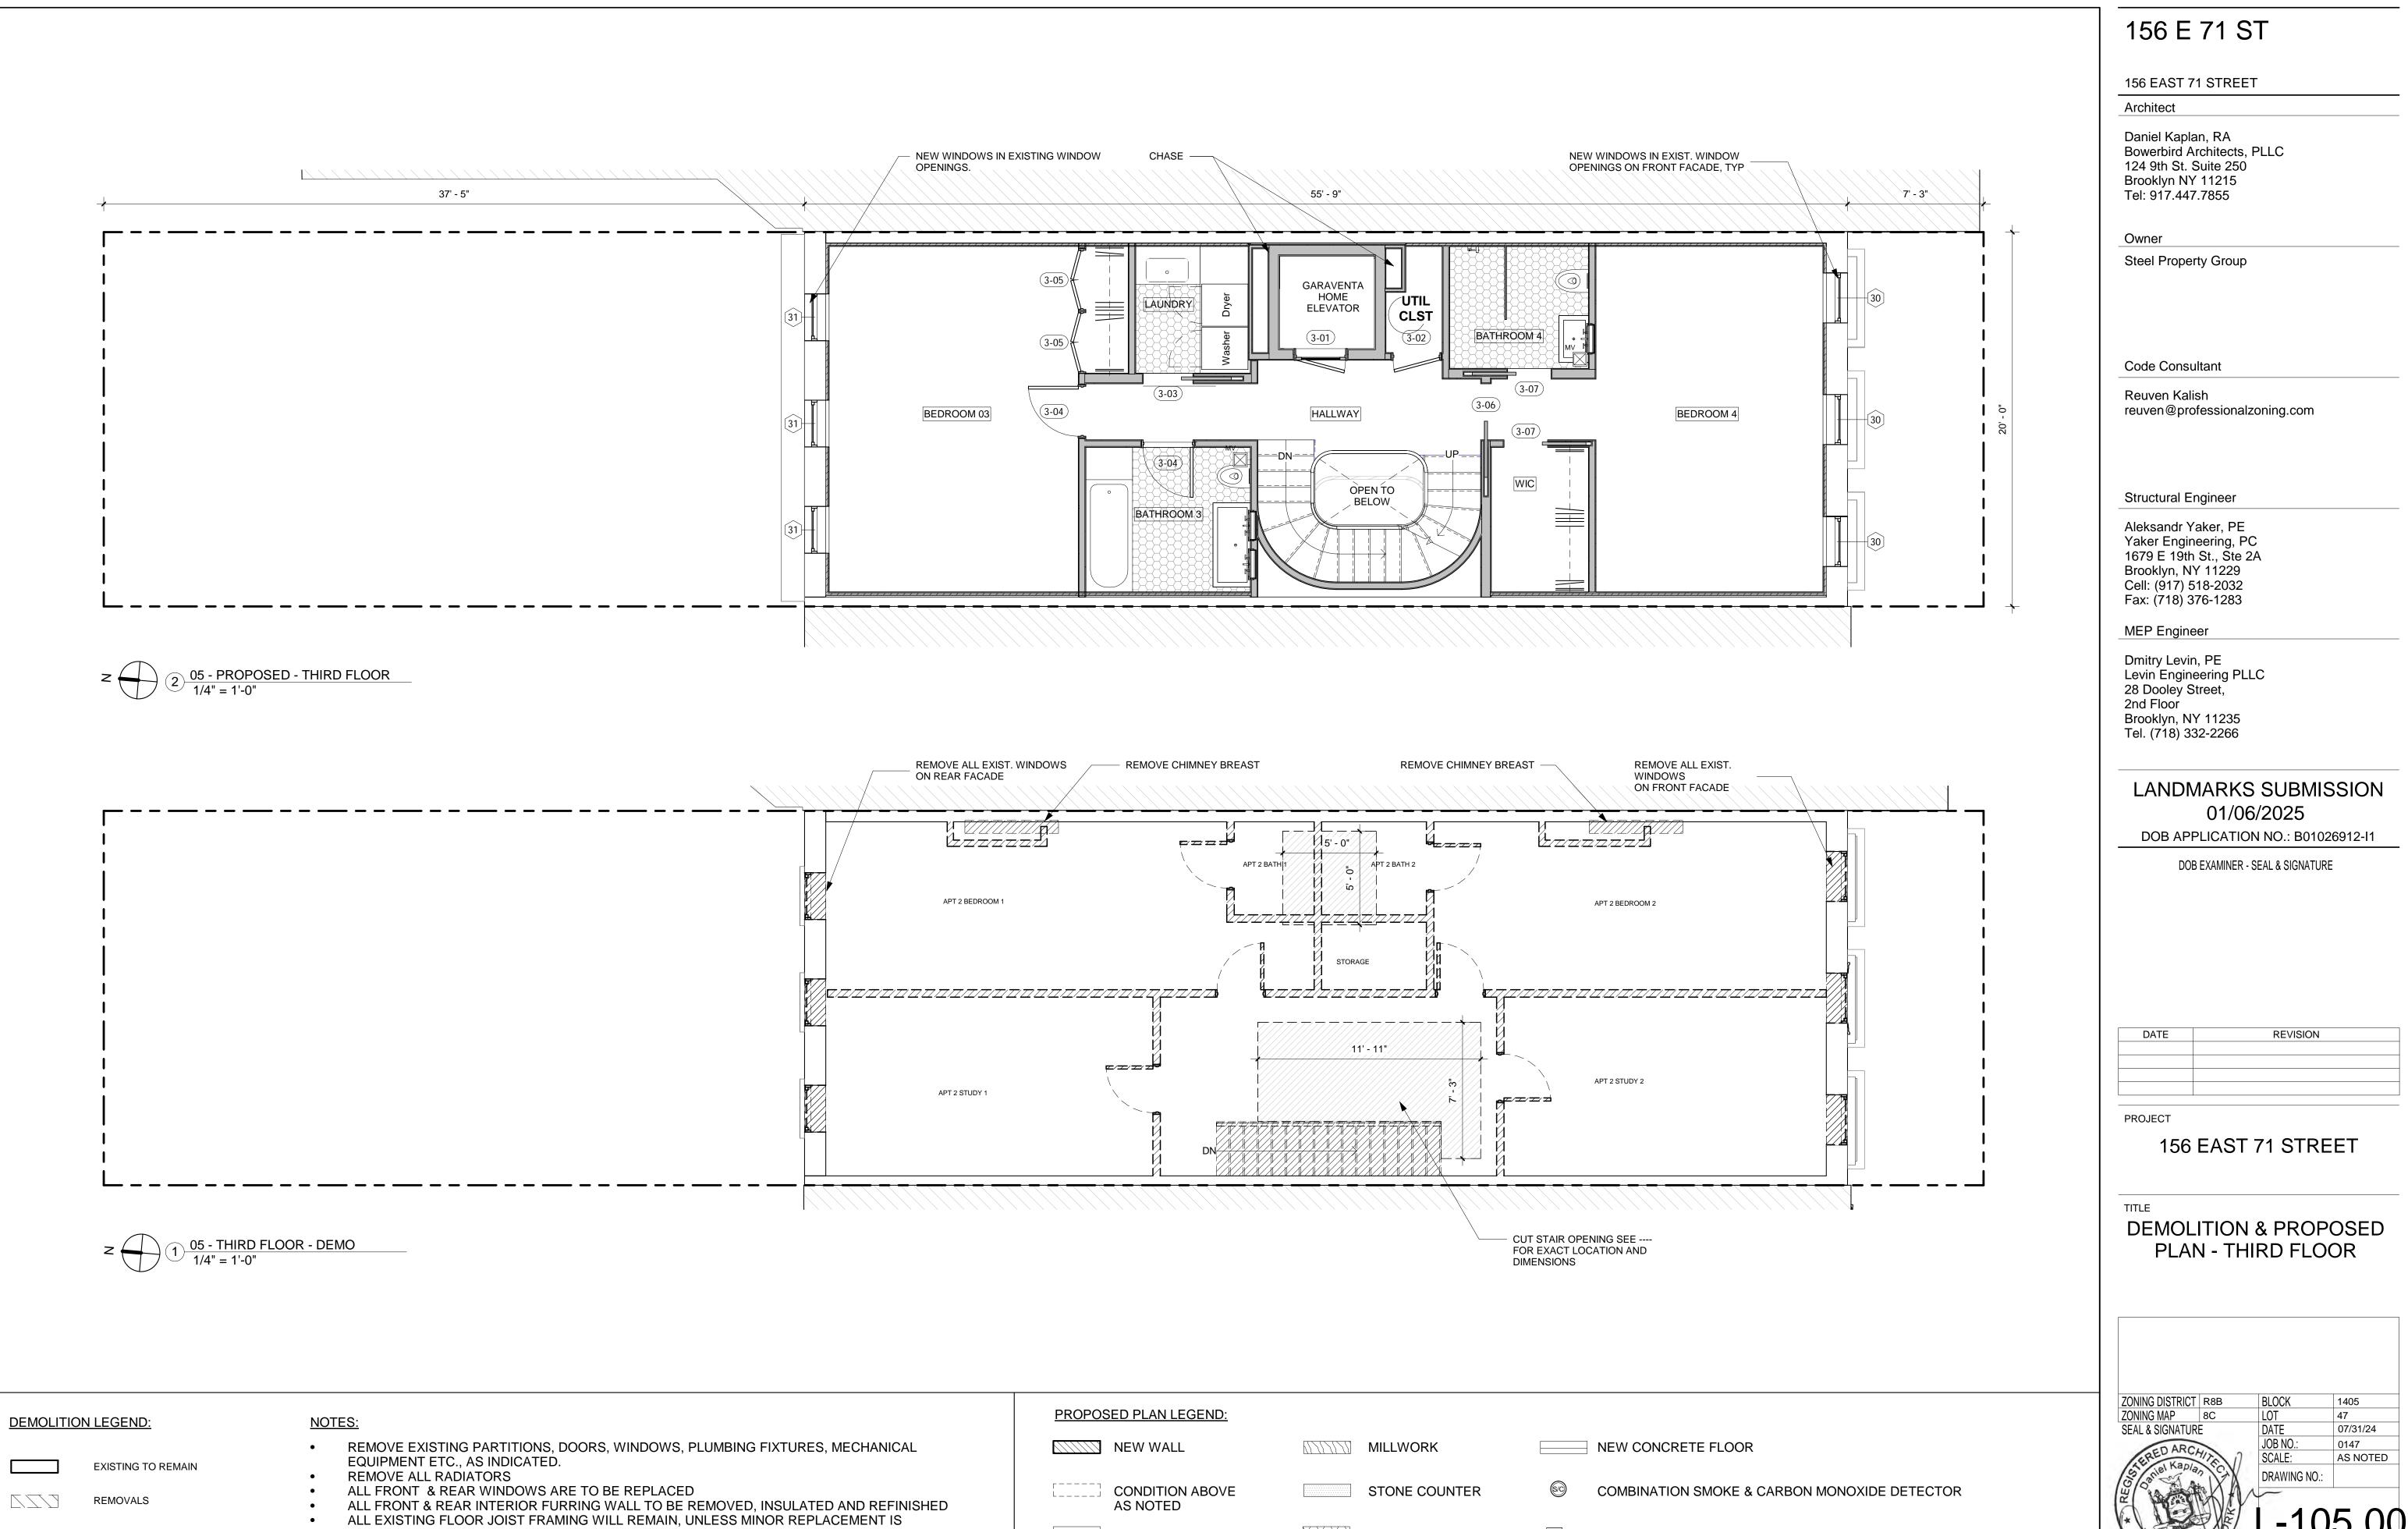

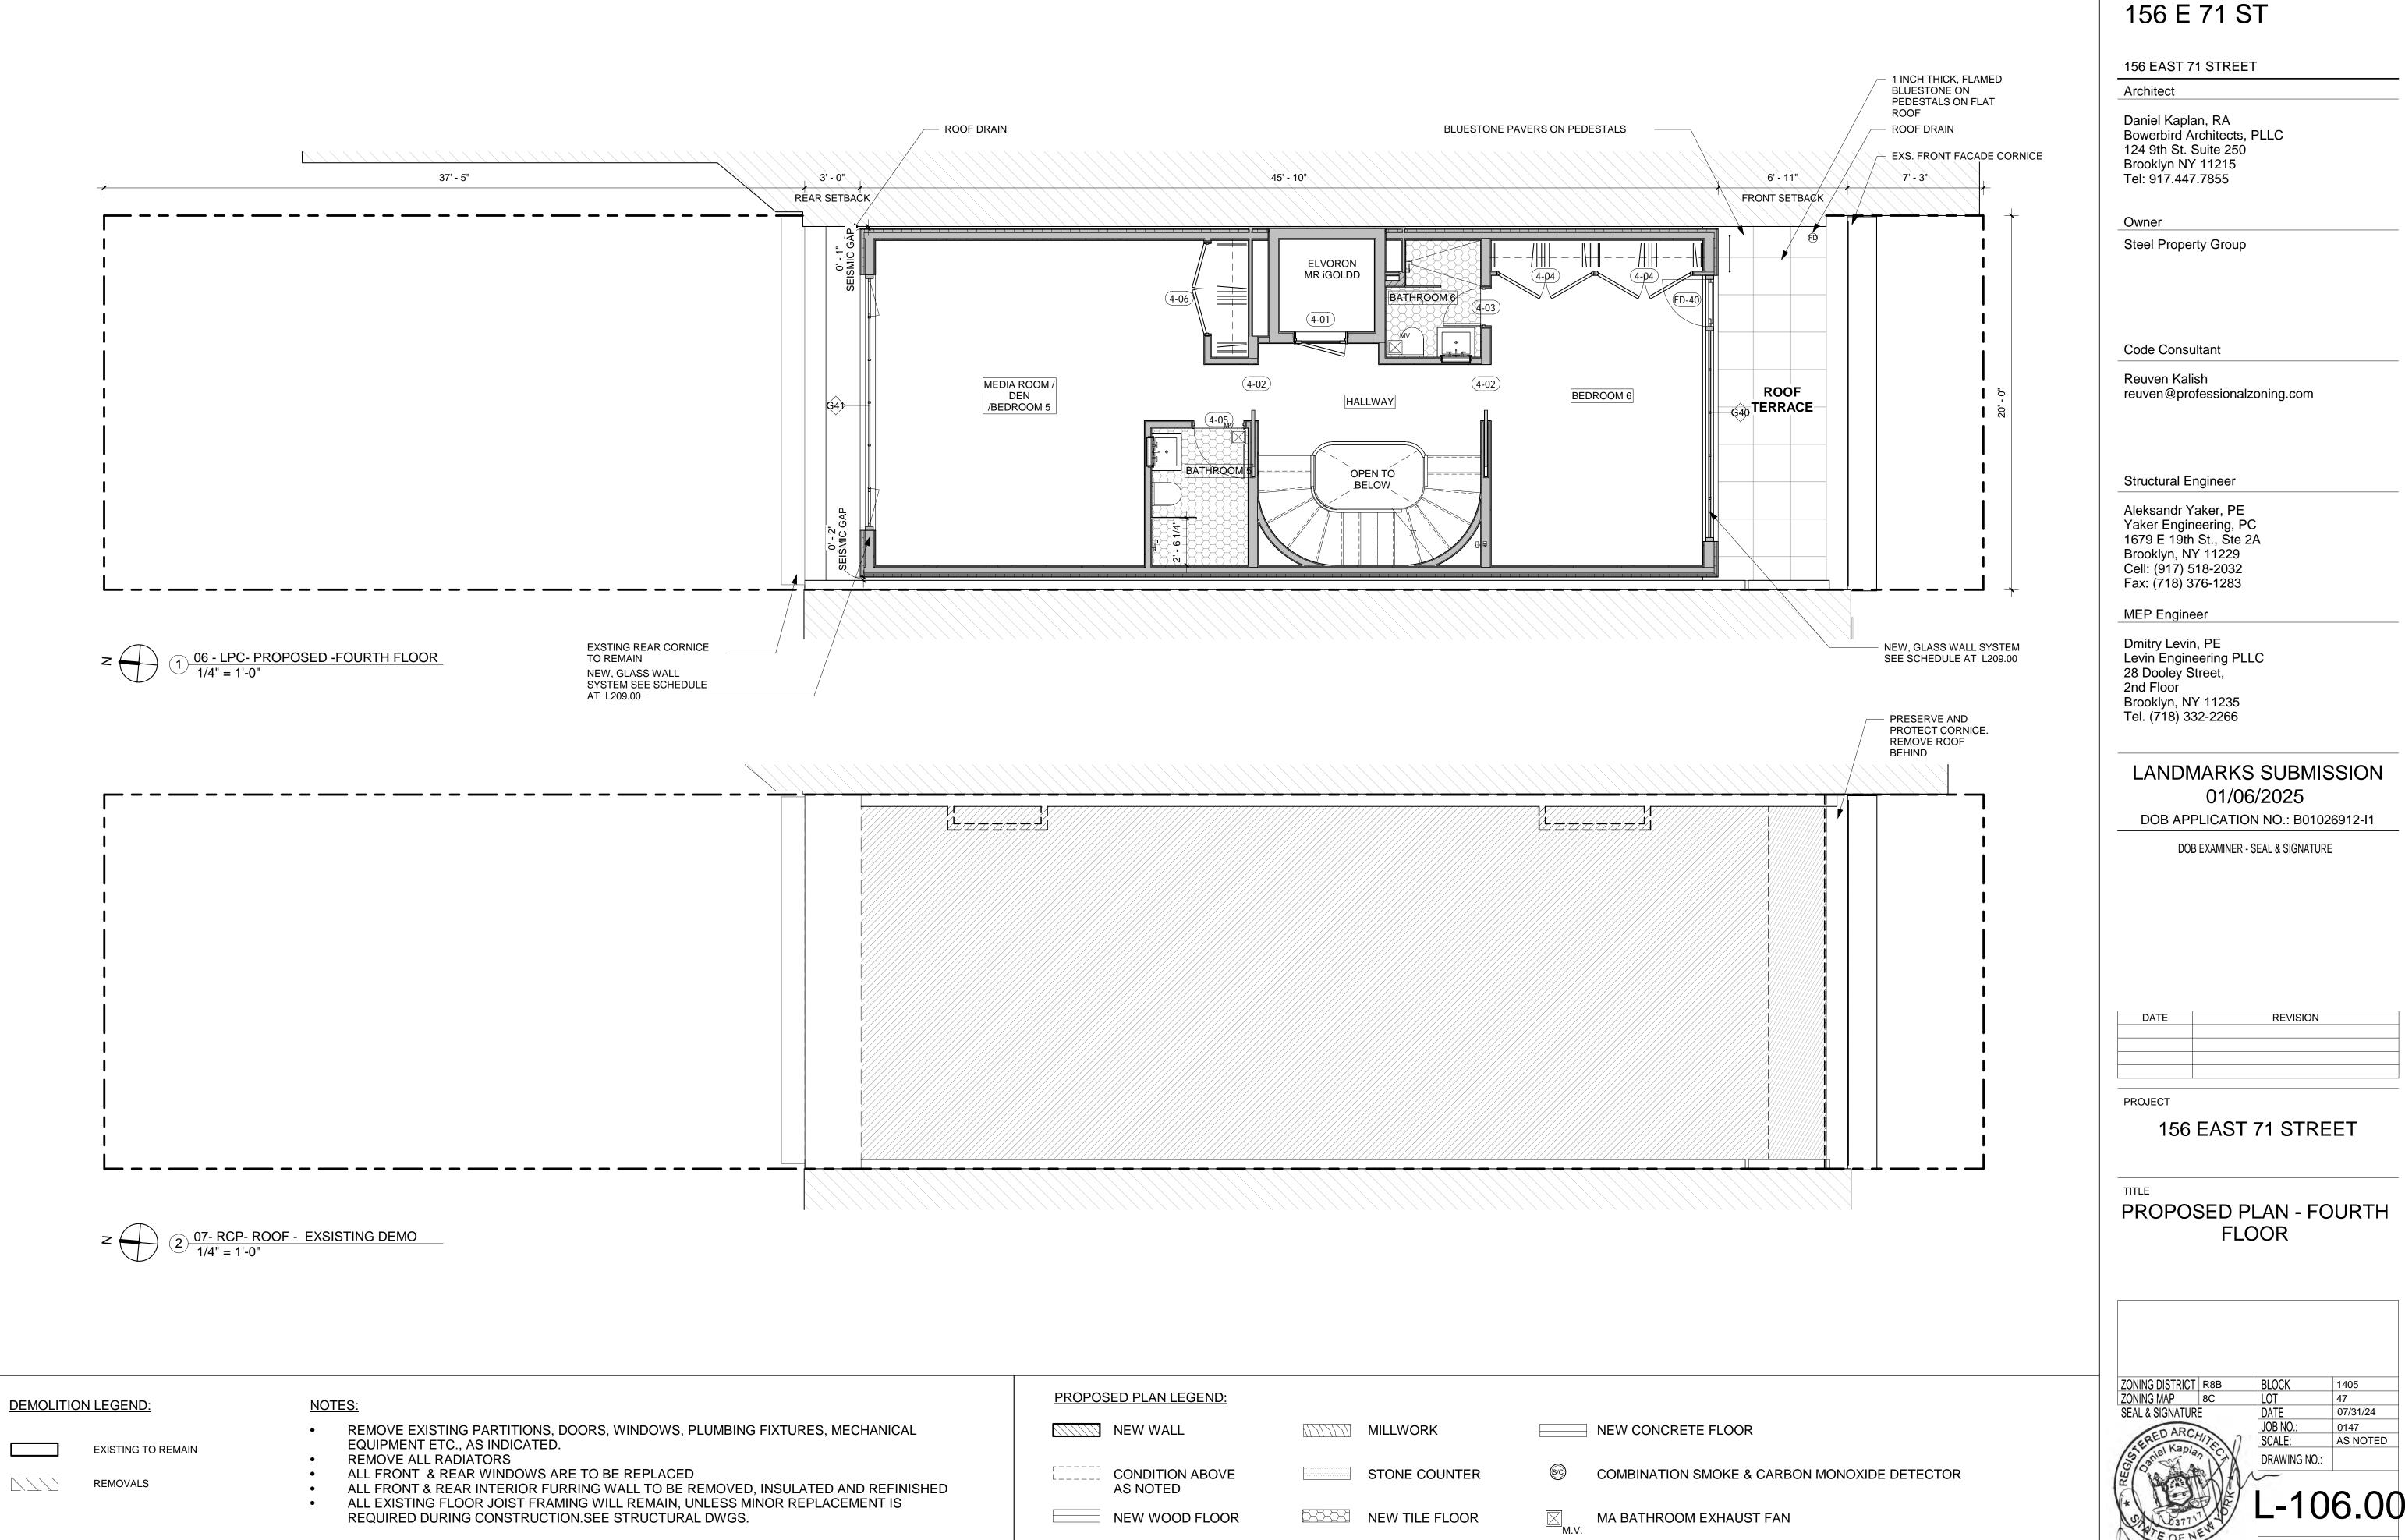
DEMOLITION LEGEND:



	PROPOSED PLAN LEGEND:		
ECHANICAL	NEW WALL	MILLWORK	NEW CONCRETE FLOOR
	CONDITION ABOVE	STONE COUNTER	© COMBINATION SMOKE & CAR
MENT IS	NEW WOOD FLOOR	NEW TILE FLOOR	MA BATHROOM EXHAUST FA





1 <u>LPC - FRONT FACADE - DEMO</u> 1/4" = 1'-0"

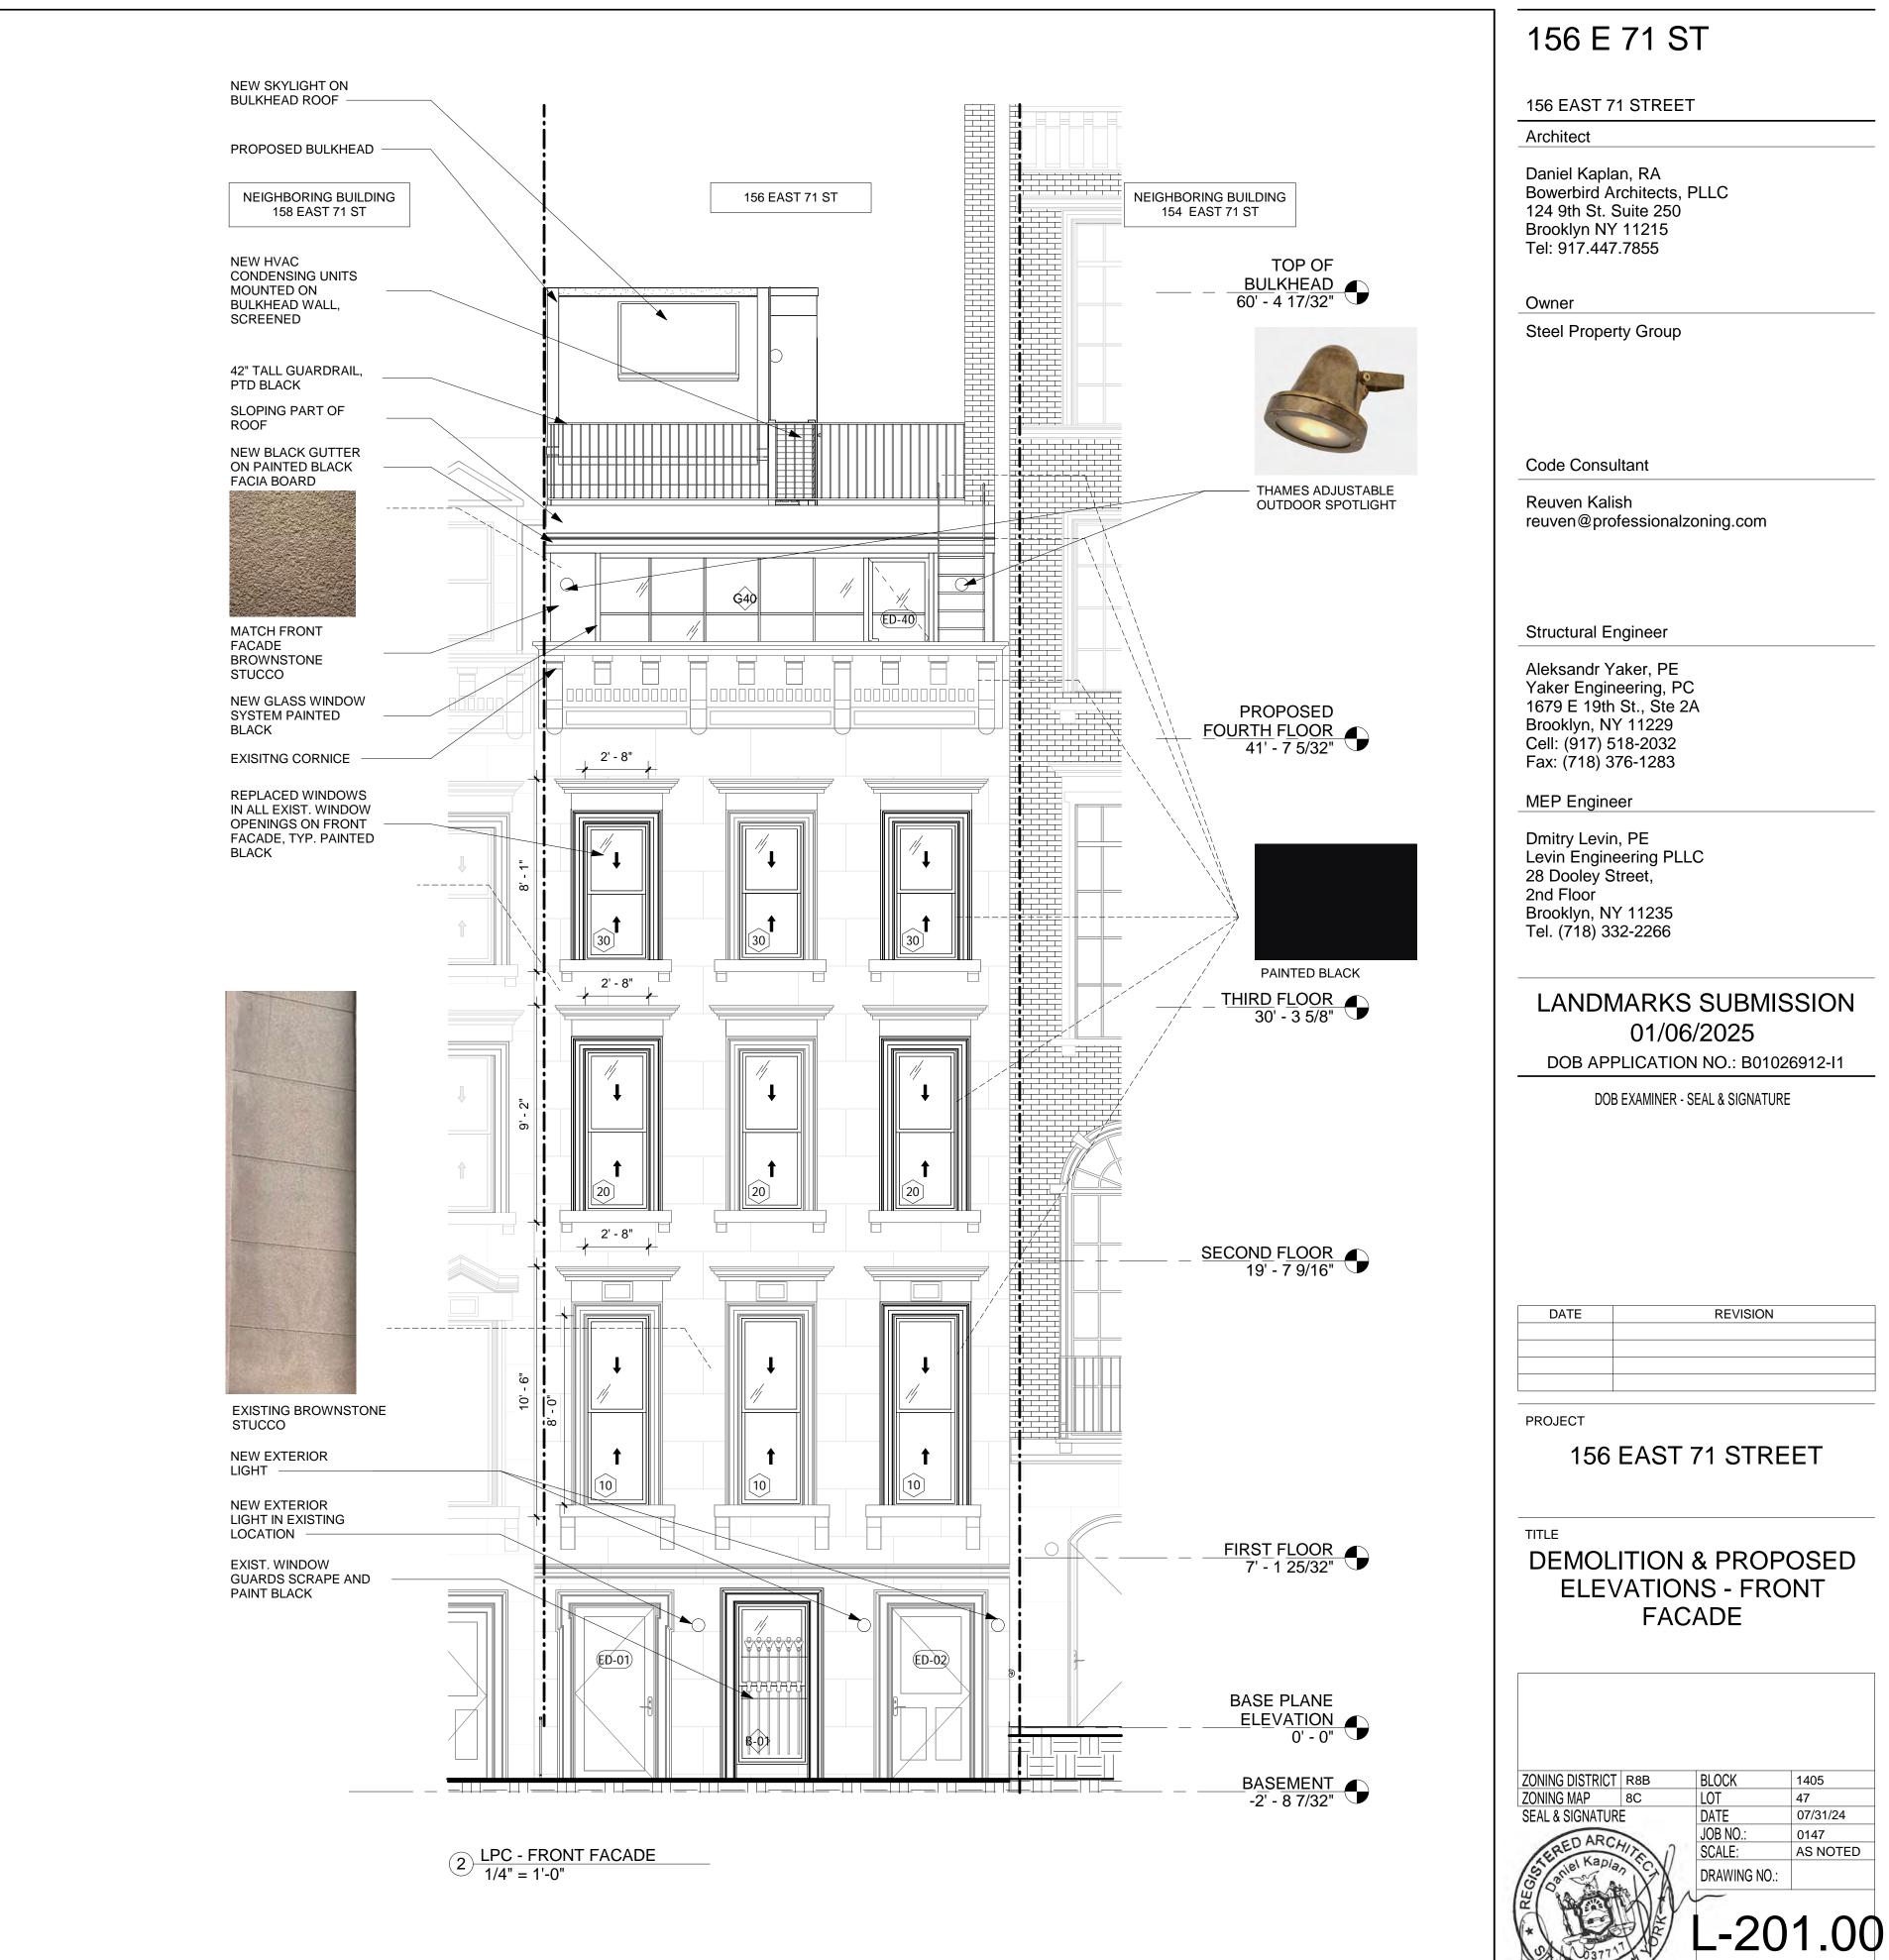

© BOWERBIRD ARCHITECTS 2024 - DO NOT SCALE FROM DRAWINGS

EOFT

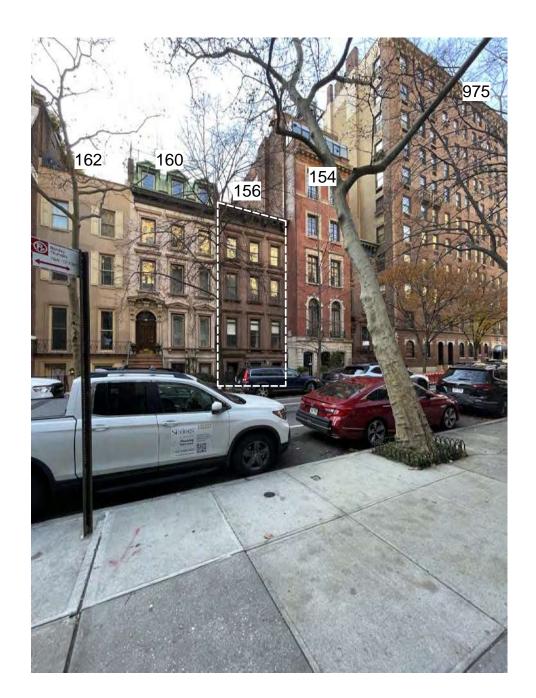

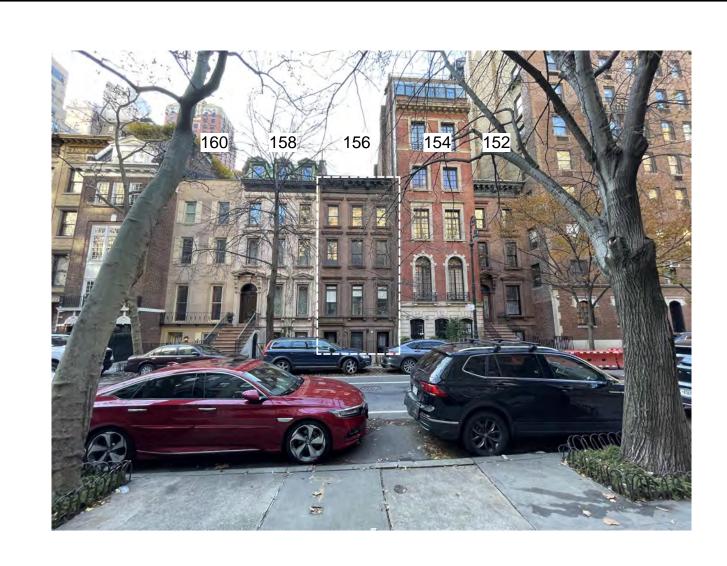

NEIGHBORING BUILDING 158 EAST 71 ST





156 EAST 71 ST



156 E 71 ST

156 EAST 71 STREET

Architect

Daniel Kaplan, RA Bowerbird Architects, PLLC 124 9th St. Suite 250 Brooklyn NY 11215 Tel: 917.447.7855

Owner

Steel Property Group

Code Consultant

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Structural Engineer

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DOB APPLICATION NO.: B01026912-I1

DOB EXAMINER - SEAL & SIGNATURE

DATE	REVISION


PROJECT

156 EAST 71 STREET

TITLE

PROPOSED FRONT ELEVATION AND NEIGHBORING BUILDINGS

	DOD	DI OCK	1405
ZONING DISTRICT ZONING MAP	R8B 8C	BLOCK LOT	1405 47
		DATE	07/31/24
ID APO		JOB NO.:	0147
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EOFN			
© BOWERBIRD ARCHI	TECTS 2024 - DO	NOT SCALE FROM DRA	WINGS

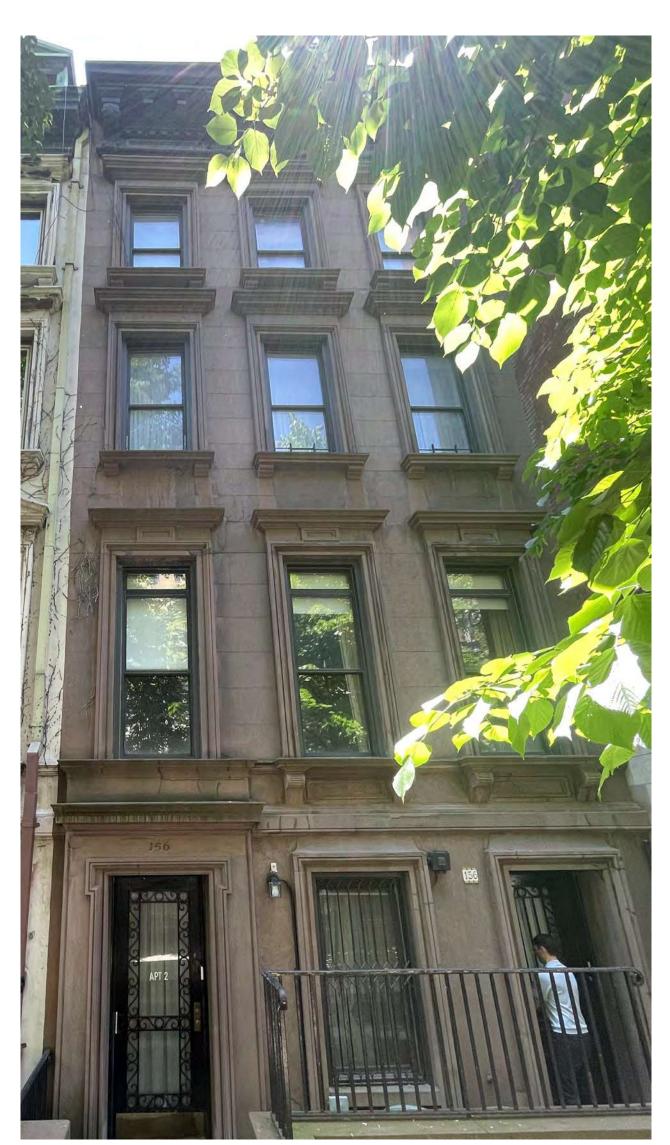

FRONT FACADE

DOORS TO REMAIN. SCRAPE, REPAINT, AND REPLACE EXISTING GLASS WITH INSULATED GLASS

156 0010100 103-

EXIST. BASEMENT FL. WINDOW W/ STONE MOLDINGS & GRILLES

ALL STONE MOLDINGS SHALL REMAIN



- ORIGINAL GRILLS TO REMAIN. SCRAPE & PAINT BLACK

PARLOR FLOOR WINDOW W/ STONE MOLDING

ALL STONE MOLDINGS SHALL REMAIN



SECOND FLOOR WINDOW W/ STONE MOLDING



ALL STONE MOLDINGS SHALL REMAIN

EXIST. 3RD FL. WINDOWS W/ STONE MOLDINGS & CORNICE

156 E 71 ST

156 EAST 71 STREET

Architect

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REVISION

PROJECT

156 EAST 71 STREET

TITLE EXSISTING FRONT FACADE CLOSE UP PHOTOS


ZONING DISTRICT	R8B	BLOCK	1405
ZONING MAP	8C	LOT	47
SEAL & SIGNATURI		DATE	07/31/24
DARC		JOB NO.:	0147
EREDANCA	1/2 D	SCALE:	AS NOTED
SEAL & SIGNATURI	2 SA	DRAWING NO .:	
HU + OBATI		L-20	3.00



EXISTING FRONT YARD - APARTMENT 2 ENTRANCE, BASEMENT WINDOW & APARTMENT 1 ENTRANCE



EXISTING BASEMENT WINDOW & FRONT ENTRANCE

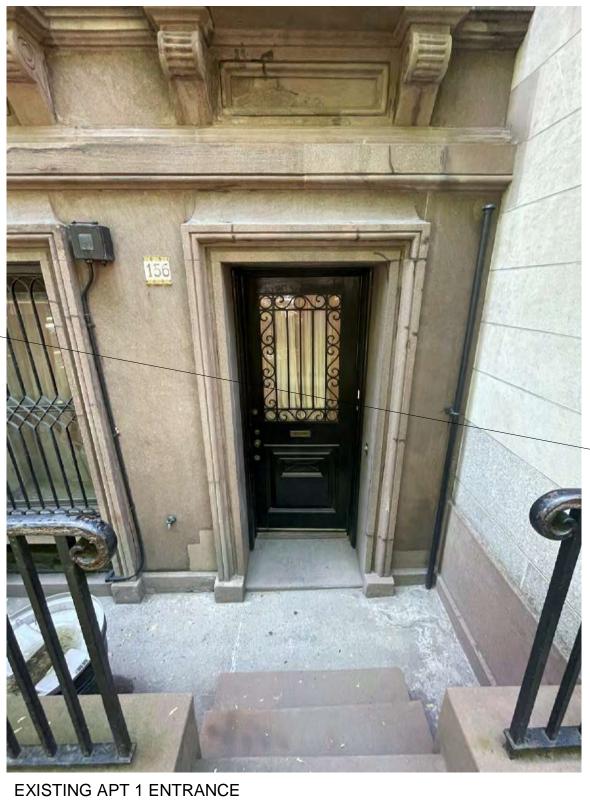



EXISTING FRONT FACADE

156 EAST 71 STREET Architect Daniel Kaplan, RA Bowerbird Architects, PLLC 124 9th St. Suite 250 Brooklyn NY 11215 Tel: 917.447.7855 Owner Steel Property Group Code Consultant Reuven Kalish reuven @professionalzoning.com Structural Engineer Aleksandr Yaker, PE Yaker Engineering, PC 1679 E 19th SL, Ste 2A Brooklyn, NY 11229 Cell: (917) 518-2032 Fax: (718) 376-1283 MEP Engineering PLLC 28 Dooley Street, 2nd Floor Brooklyn, NY 11235 Tel. (718) 332-2266 LANDMARKS SUBMISSION 01/06/2025 DOB EXAMINER - SEAL & SIGNATURE DOB EXAMINER - SEAL & SIGNATURE DOB EXAMINER - SEAL & SIGNATURE PROJECT 156 EAST 71 STREET TITLE FRONT YARD AND AREAW/	ET
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Levin Engineering PLLC 28 Dooley Street, 2nd Floor Brooklyn, NY 11235 Tel. (718) 332-2266 LANDMARKS SUBMISSION 01/06/2025 DOB APPLICATION NO.: B01026912-11 DOB EXAMINER - SEAL & SIGNATURE DOB EXAMINER - SEAL & SIGNATURE PROJECT 156 EAST 71 STREET TITLE	
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DOB EXAMINER - SEAL & SIGNATURE	
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156 EAST 71 STREET	
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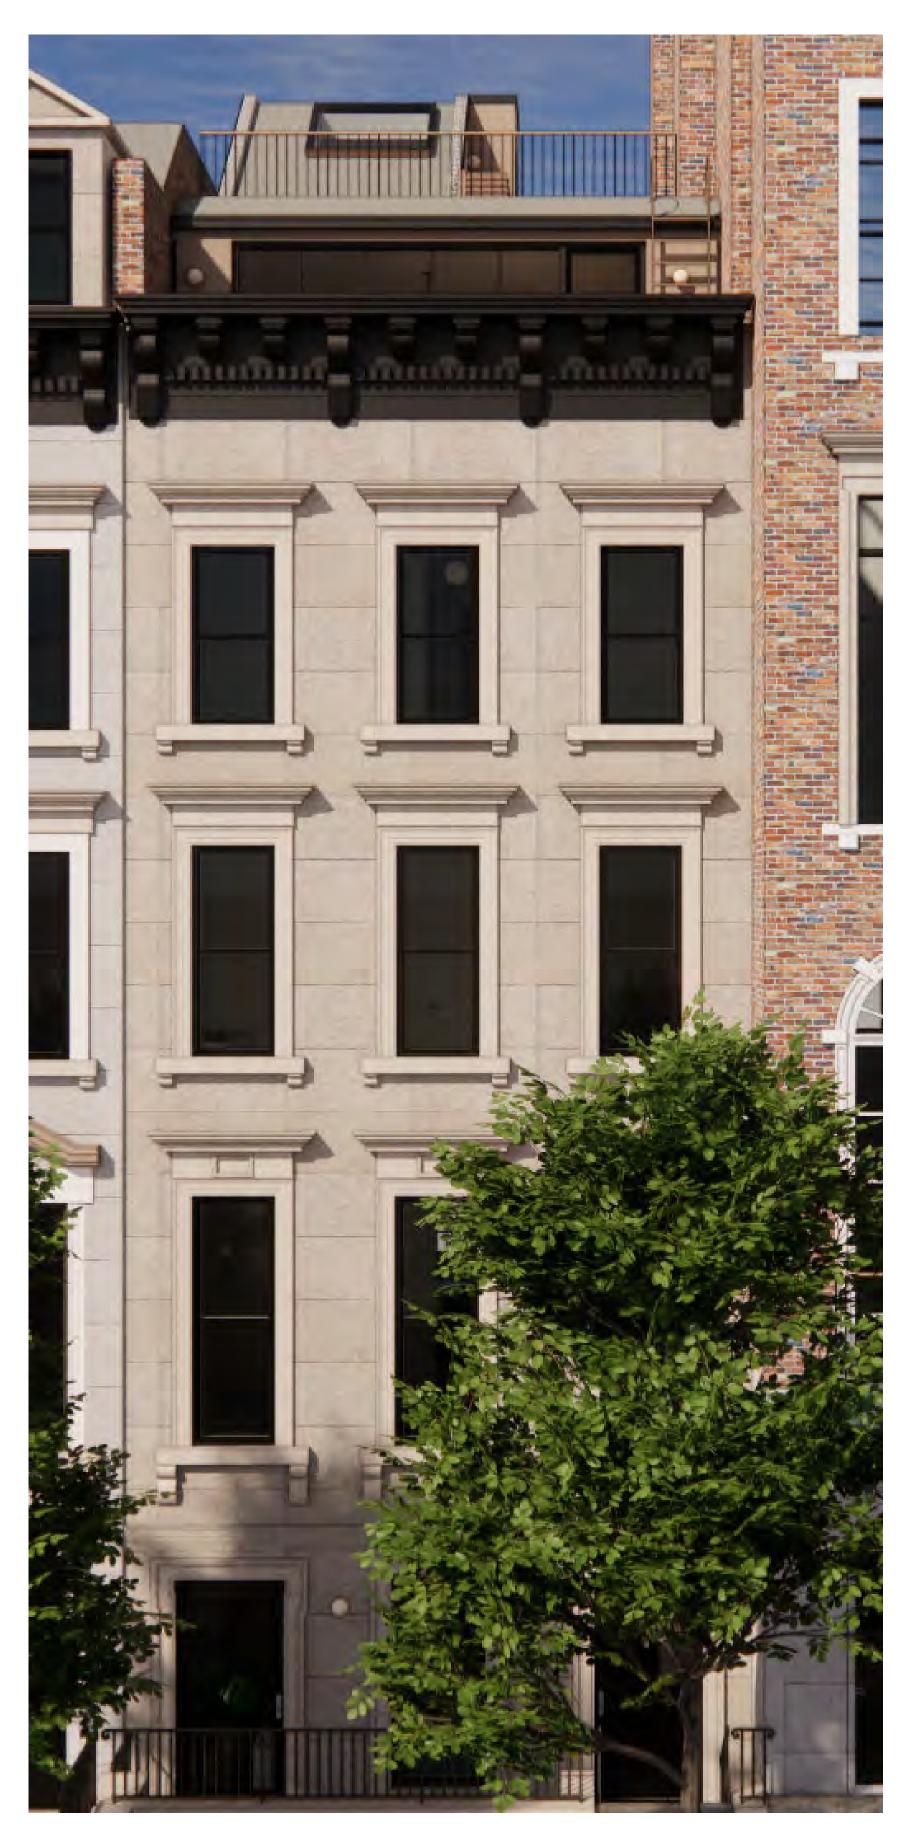
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- REMOVE CABLE

© BOWERBIRD ARCHITECTS 2024 - DO NOT SCALE FROM DRAWINGS

DRAWING NO .:

-204.00



PROPOSED FRONT FACADE



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PROPOSED FRONT FACADE ROOF ADDITION
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156 E 71 ST

156 EAST 71 STREET

Architect

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Owner

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LANDMARKS SUBMISSION 01/06/2025

DOB APPLICATION NO.: B01026912-I1

DOB EXAMINER - SEAL & SIGNATURE


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PROJECT


156 EAST 71 STREET

TITLE PROPOSED FRONT FACADE

ZONING DISTRICT	R8B	BLOCK	1405
ZONING MAP	8C	LOT	47
SEAL & SIGNATURE		DATE	07/31/24
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PROPOSED FRONT YARD - GUARDRAILS TO BE REUSED AND/OR REPLICATED TO MATCH EXISTING

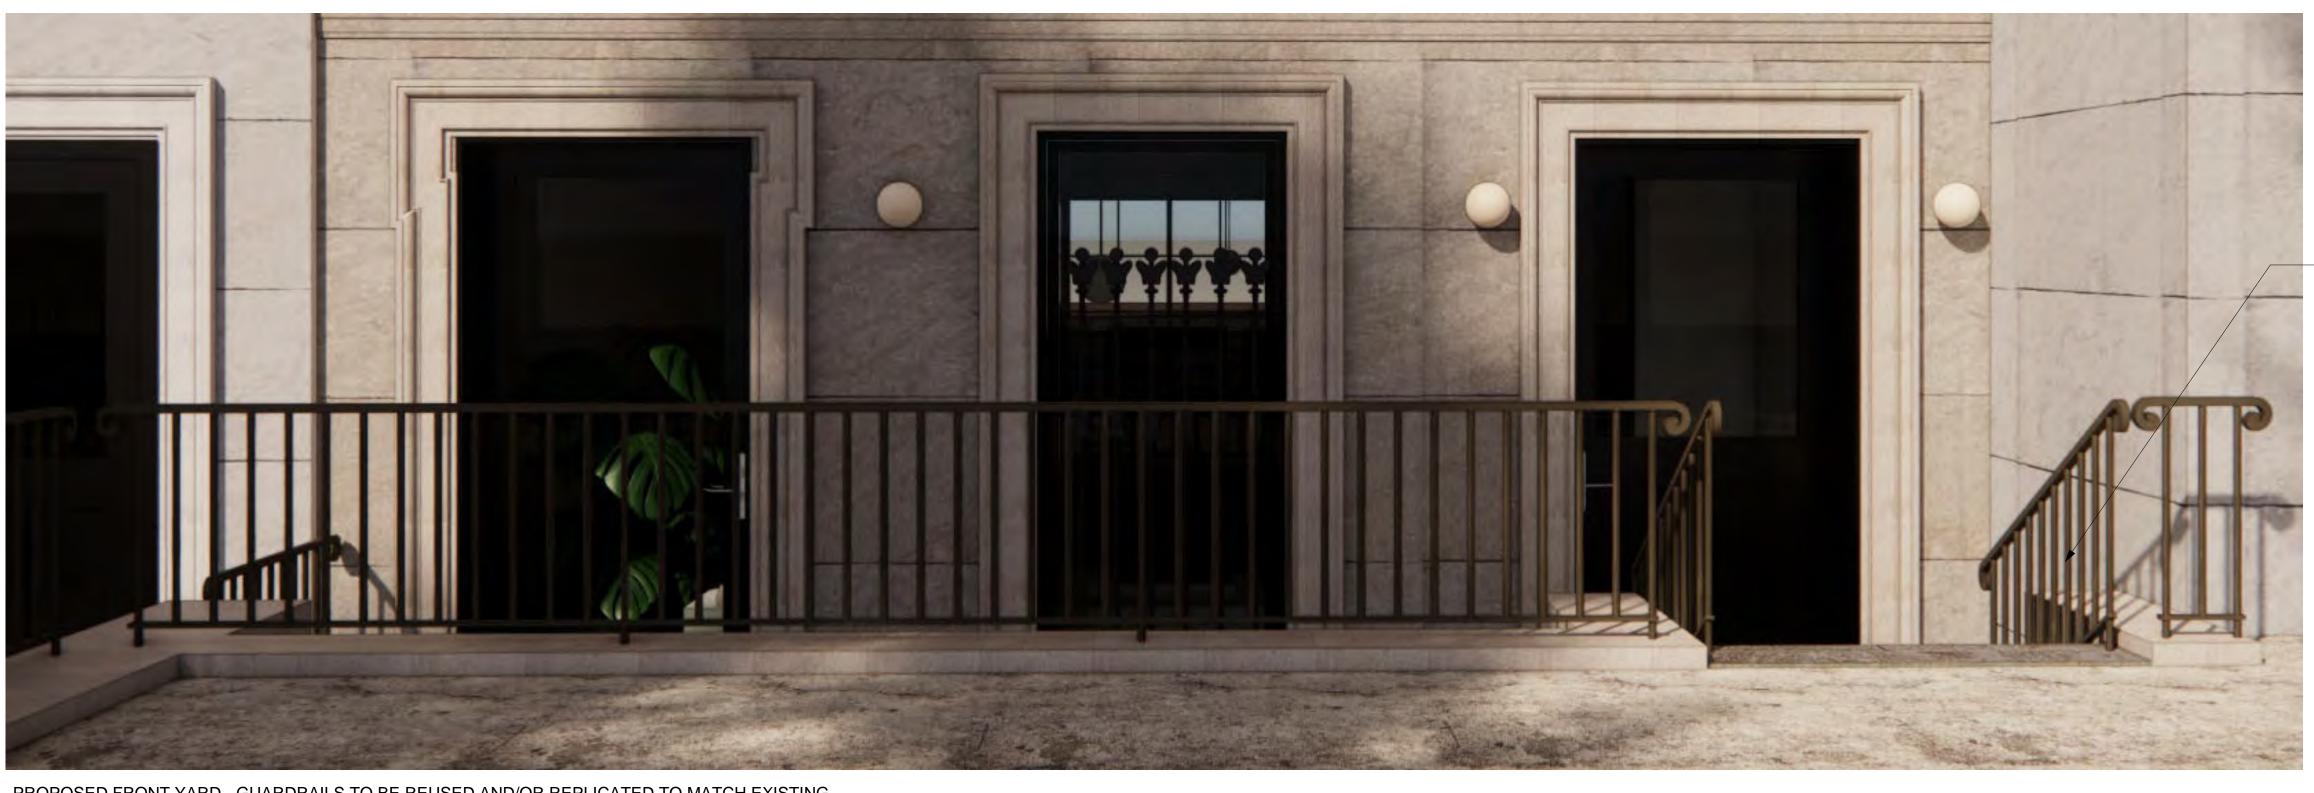

DESIGN ROOF GUARDRAIL - NOT VISIBLE FROM THE PUBLIC THROUGHWAY

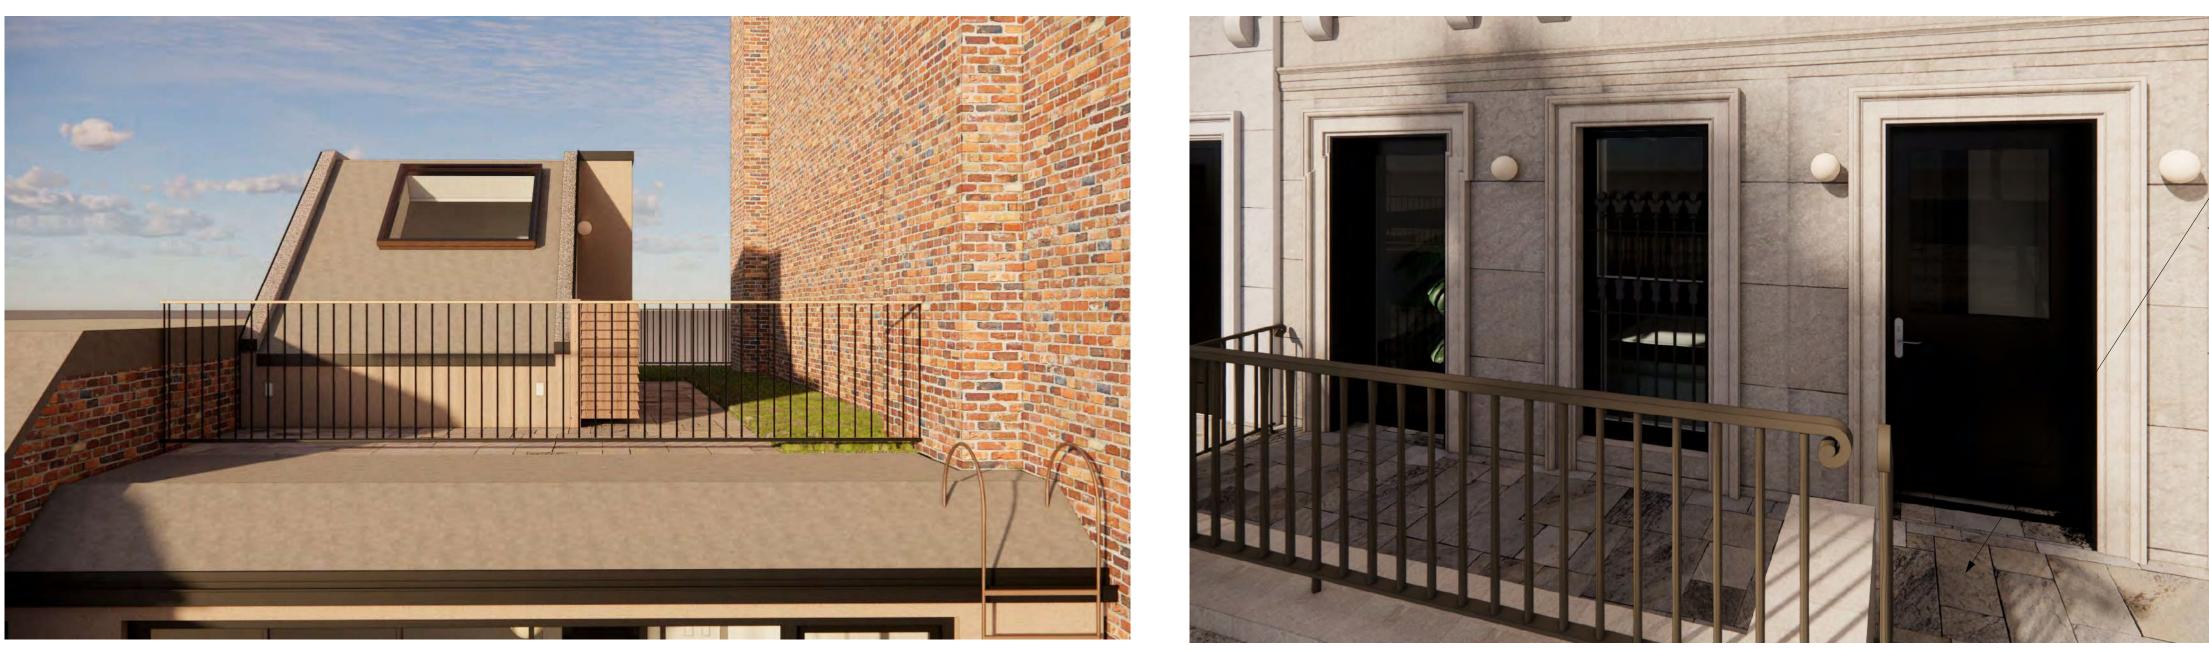REUSE EXISTING GUARDRAIL WHERE FEASIBLE OR REPLICATE WITH EXACT SAME DETAILING. PAINT BLACK



REUSE AND MATCH PAVERS FROM THE REAR YARD PATIO.

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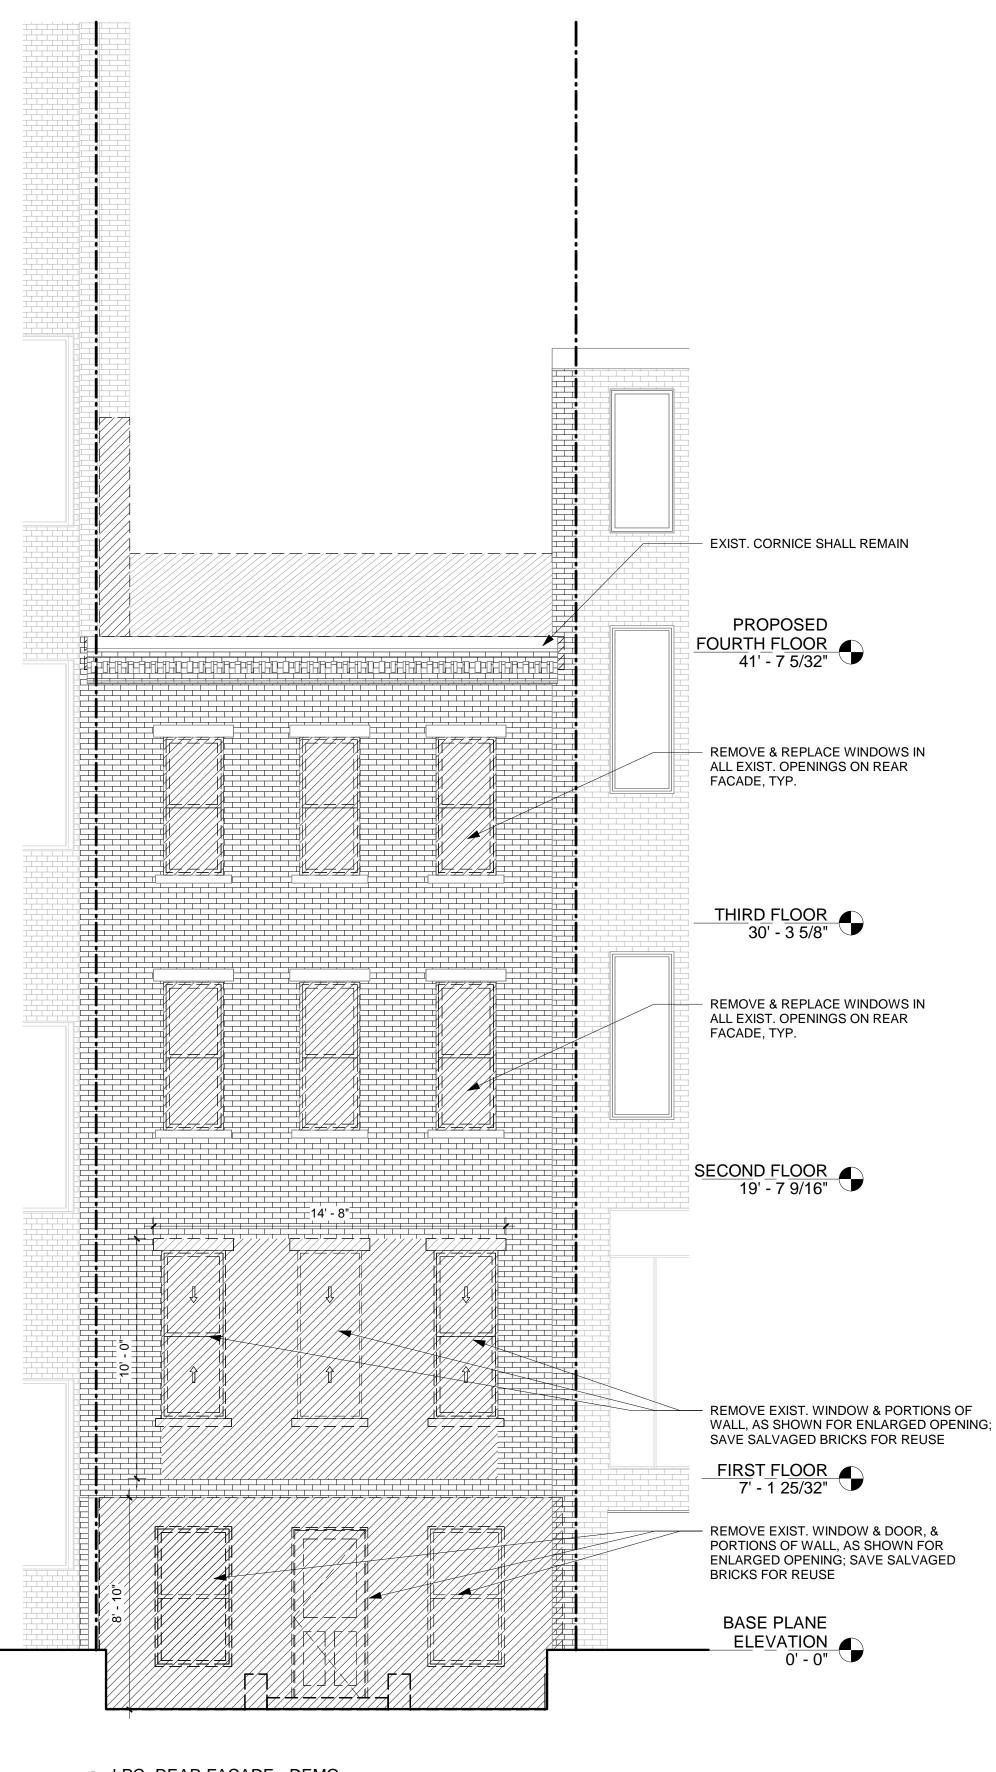
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PROJECT


156 EAST 71 STREET


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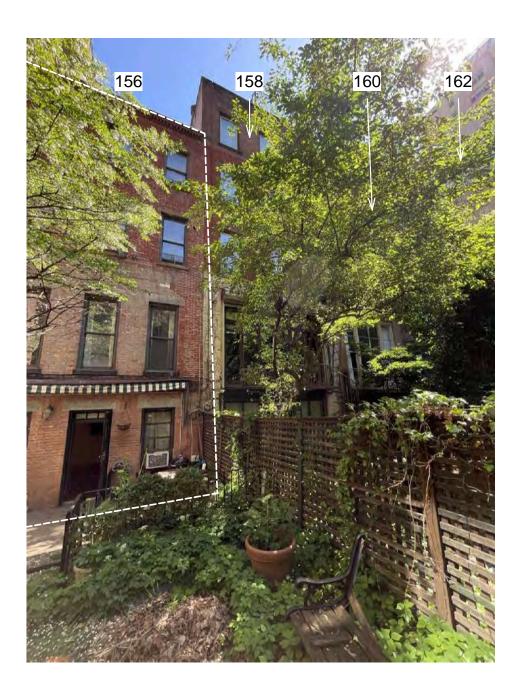
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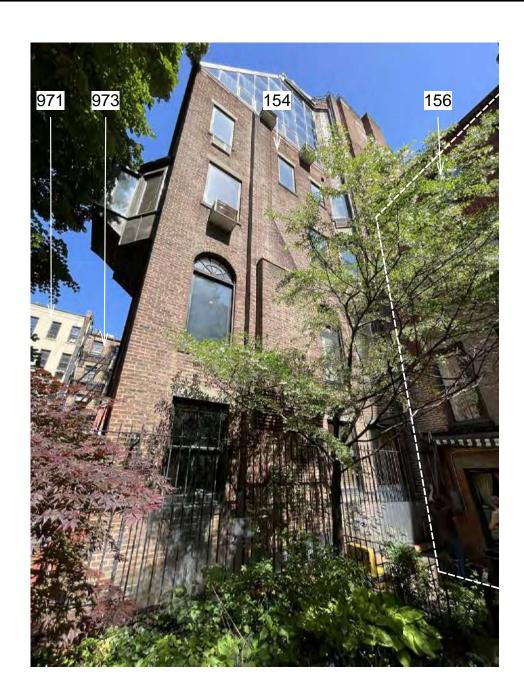



1 <u>LPC- REAR FACADE - DEMO</u> 1/4" = 1'-0"






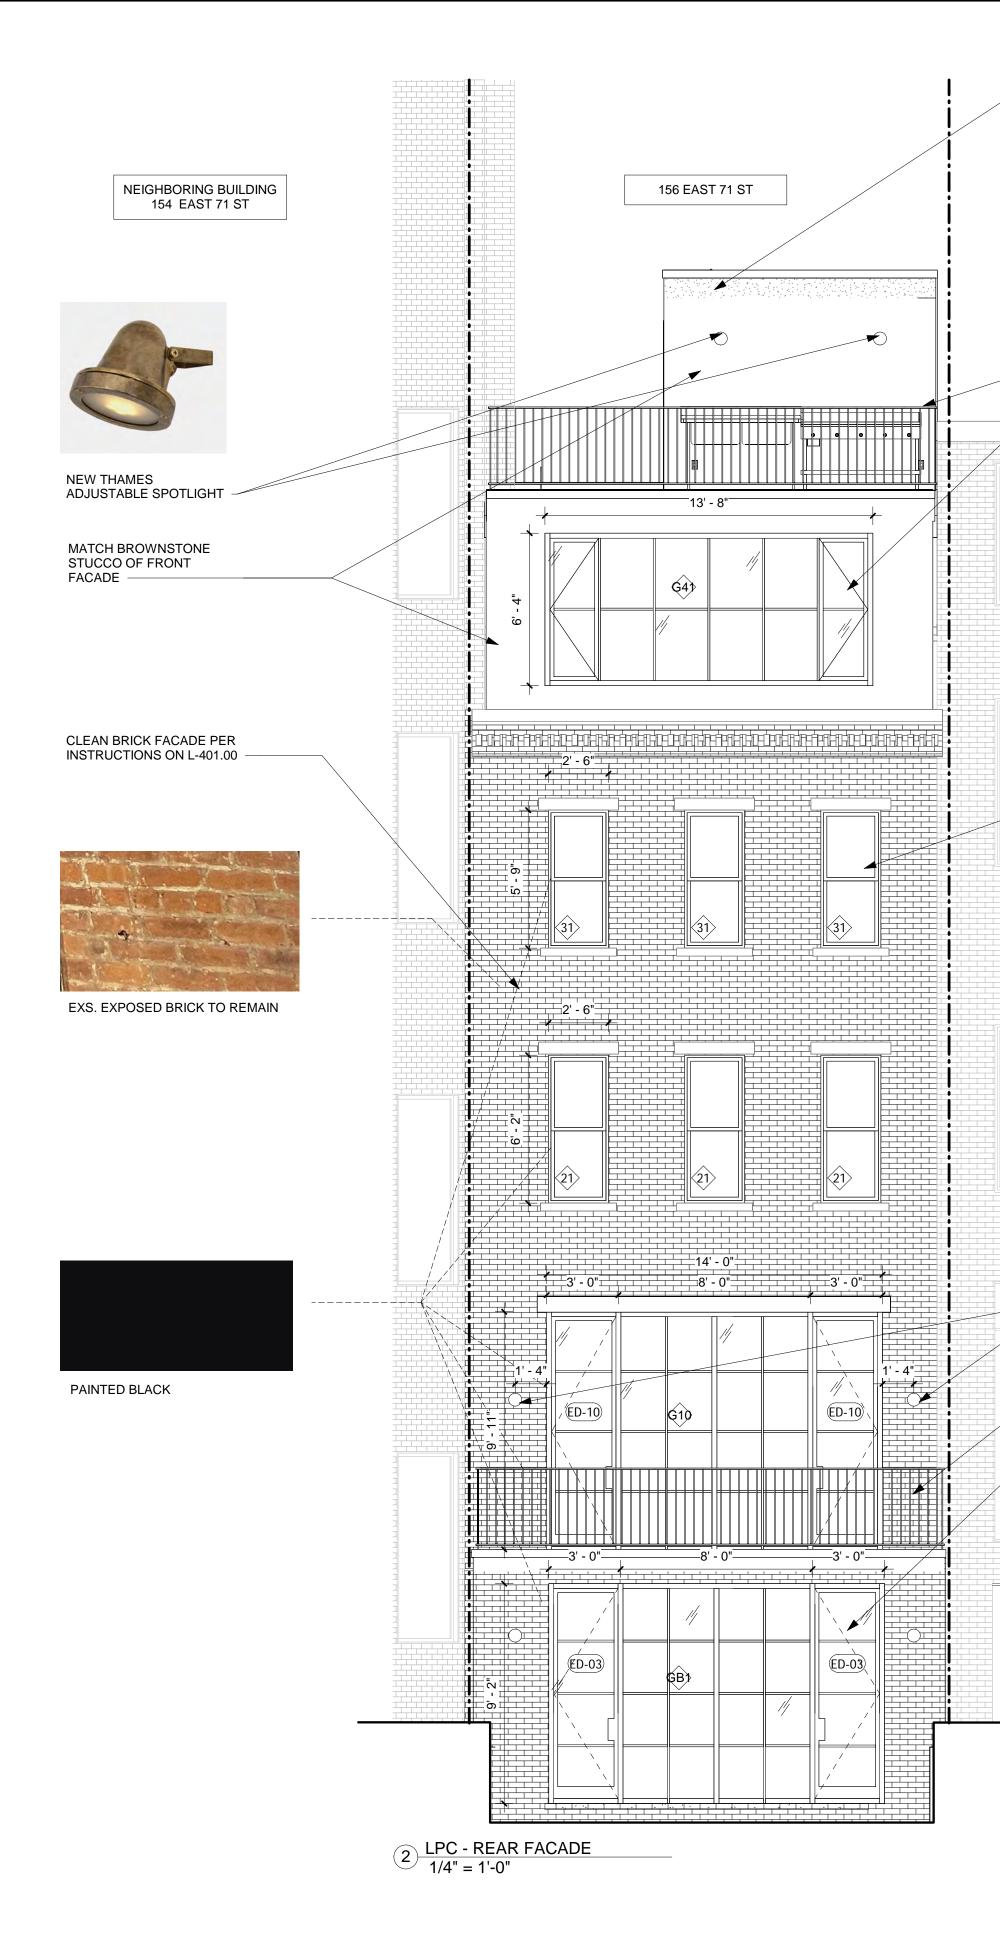


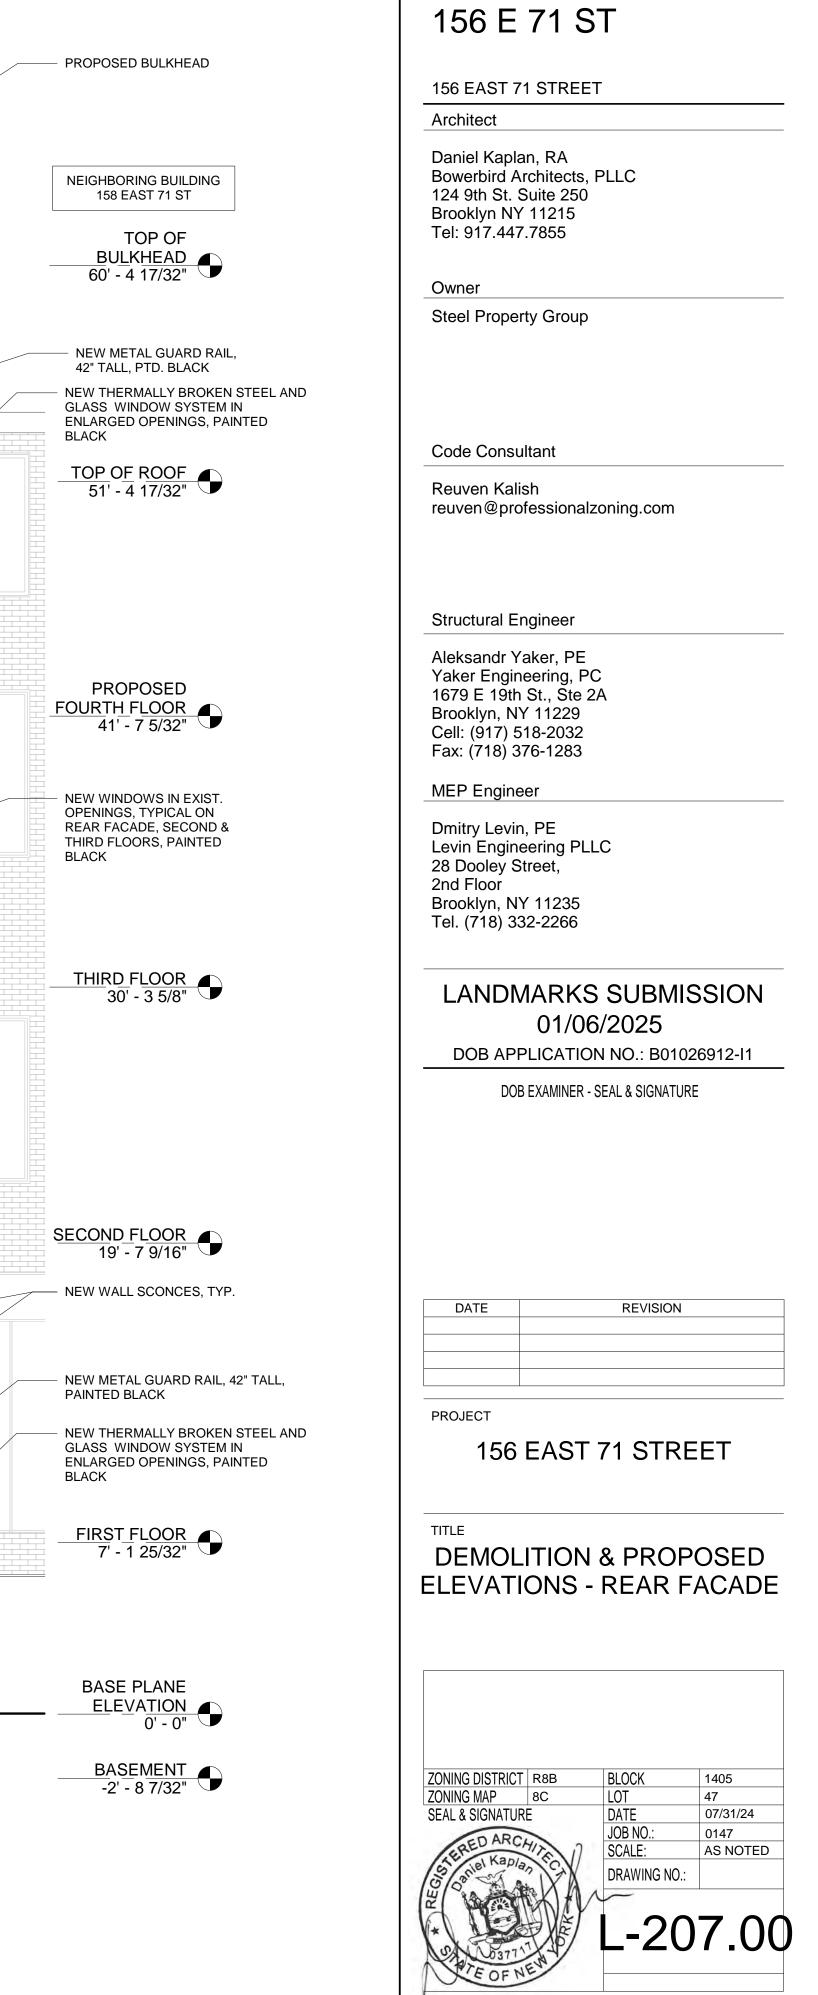

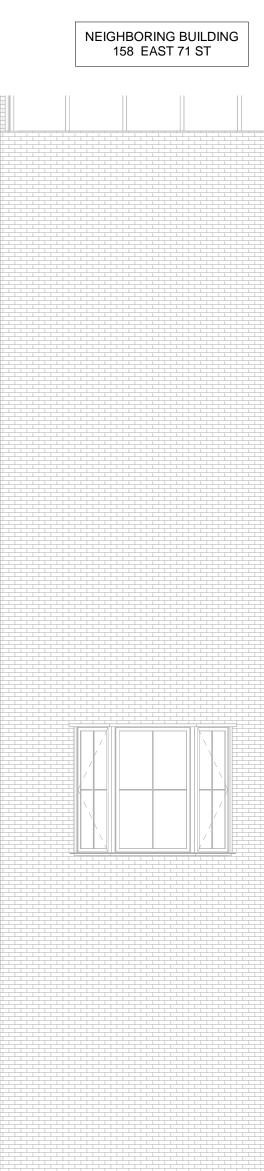

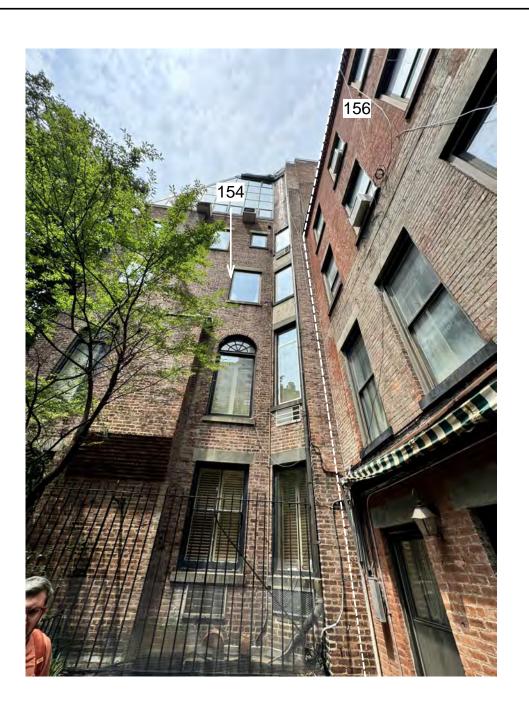



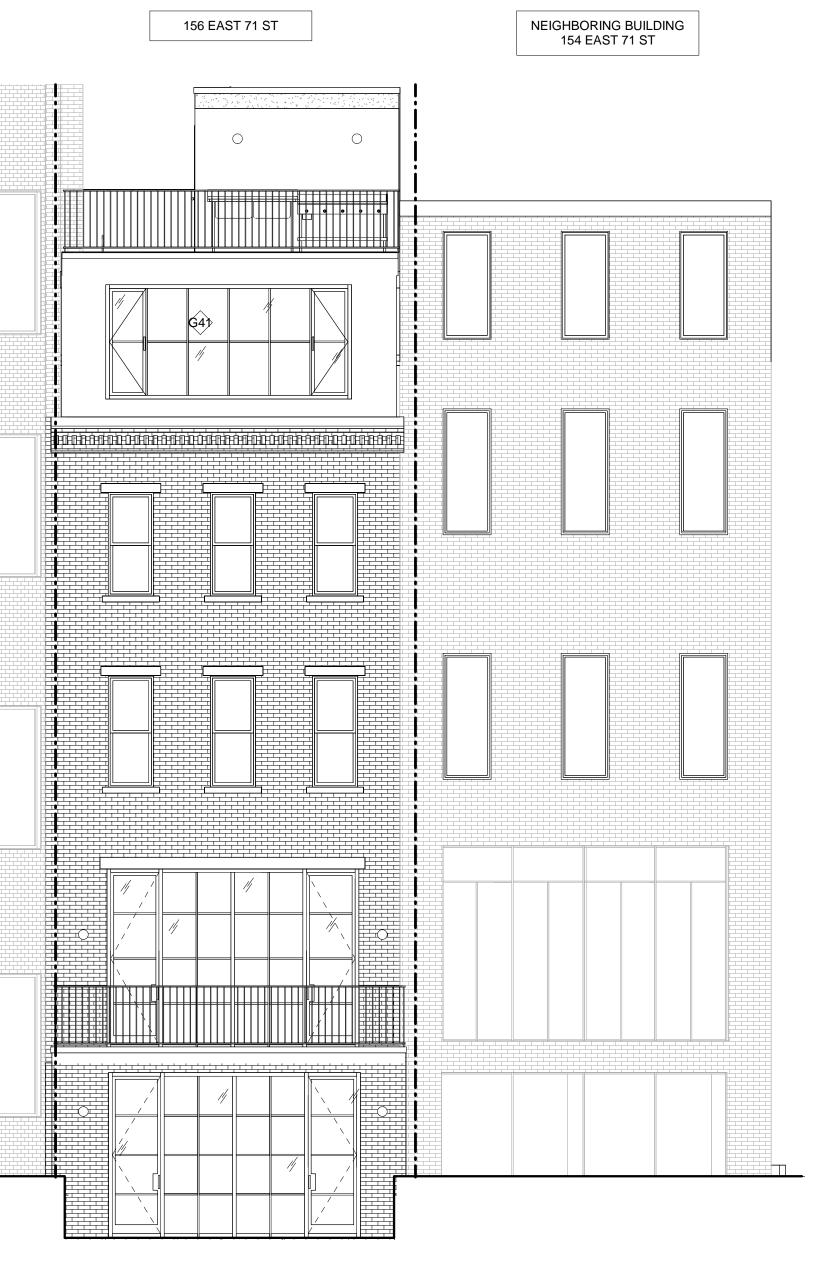

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DOB APPLICATION NO.: B01026912-I1

DOB EXAMINER - SEAL & SIGNATURE

DATE	REVISION

PROJECT

156 EAST 71 STREET

TITLE

PROPOSED REAR ELEVATION AND NEIGHBORING BUILDINGS


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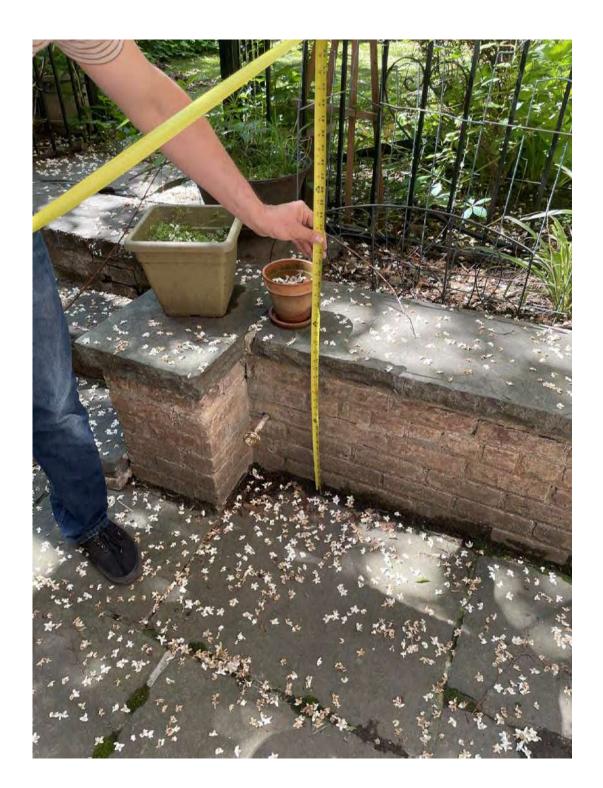


EXSISTING FENCE


VIEW ON NEIGHBORING PROPERTY



EXSISTING REAR FACADE

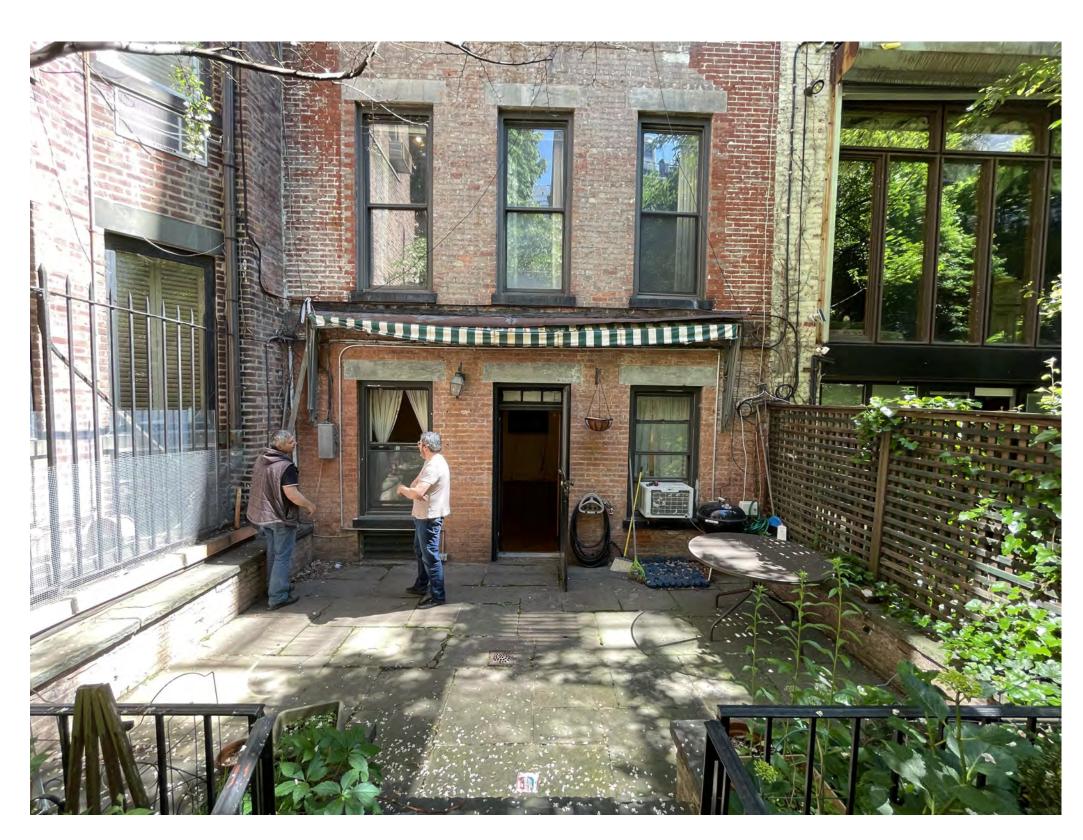



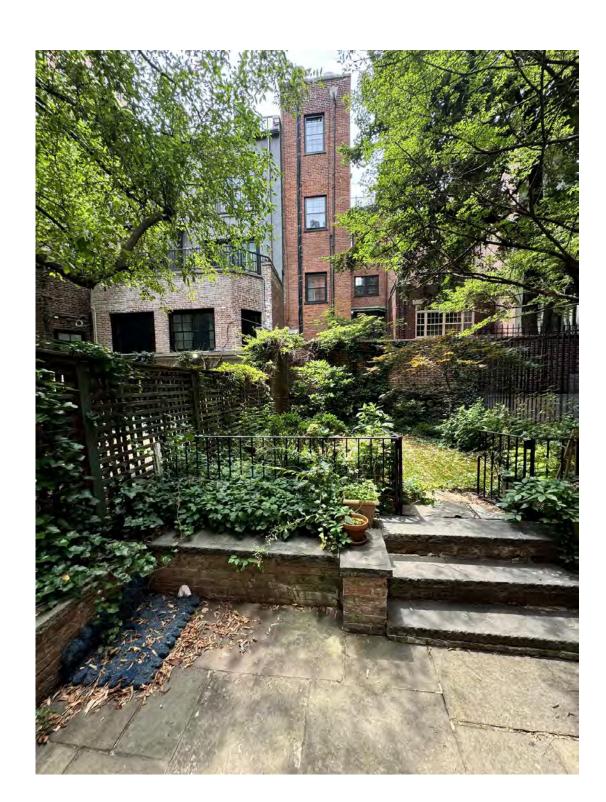

EXSISTING RETANING WALL

156 E 71 ST

156 EAST 71 STREET

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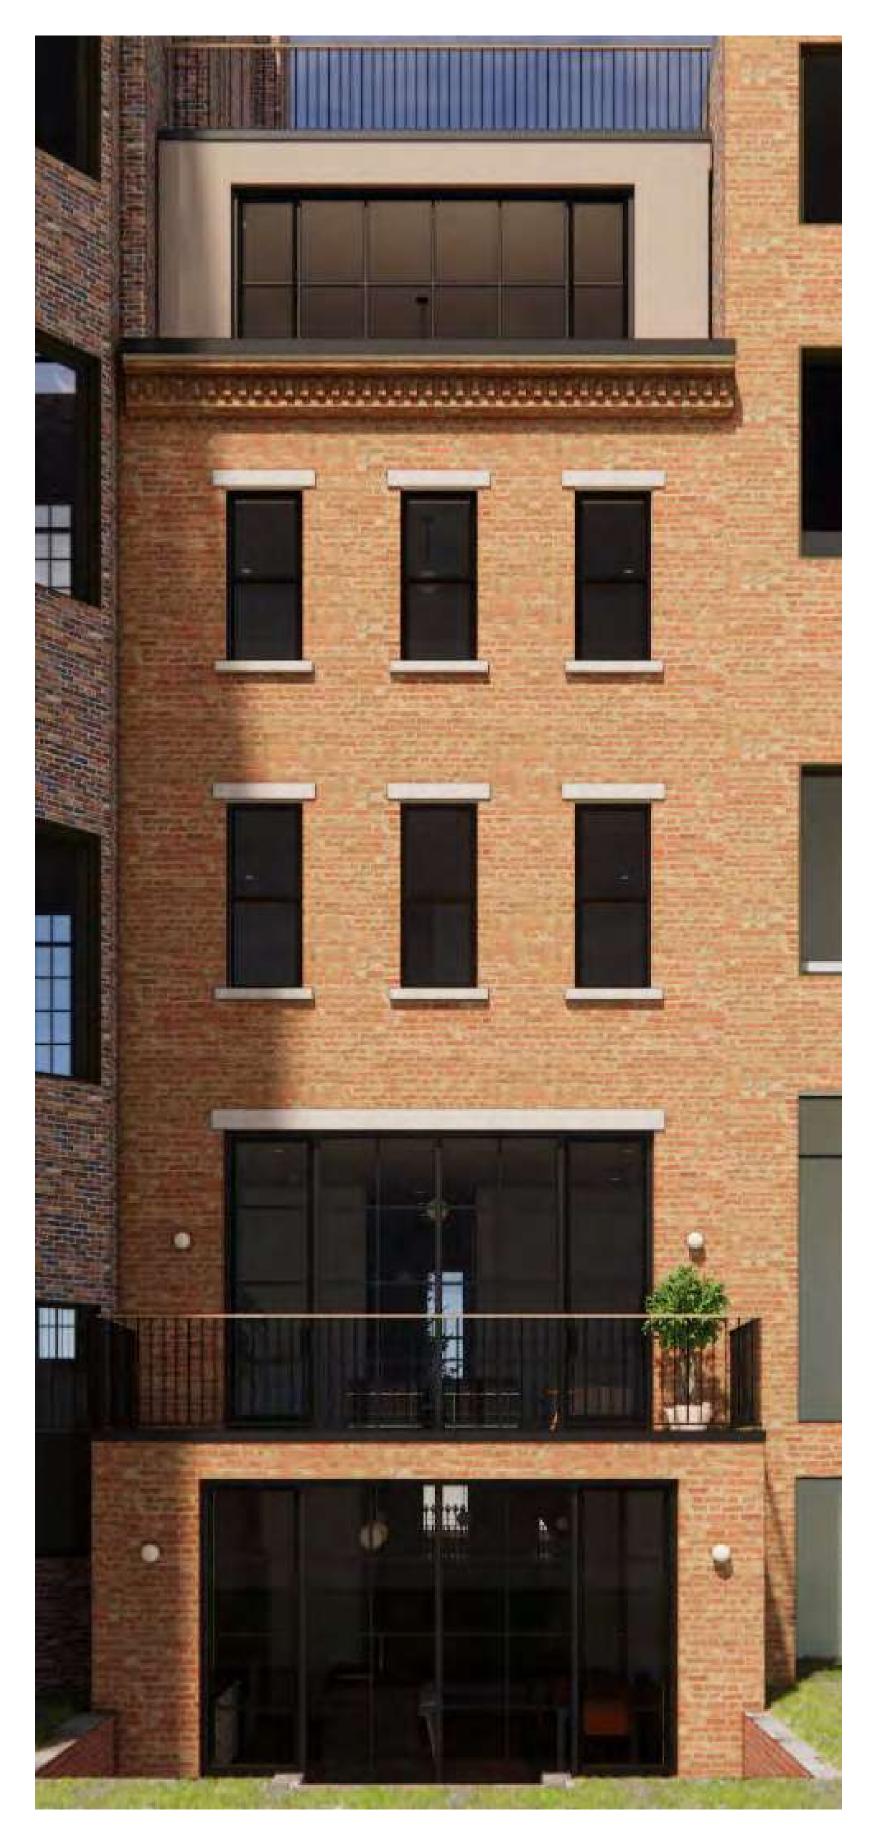
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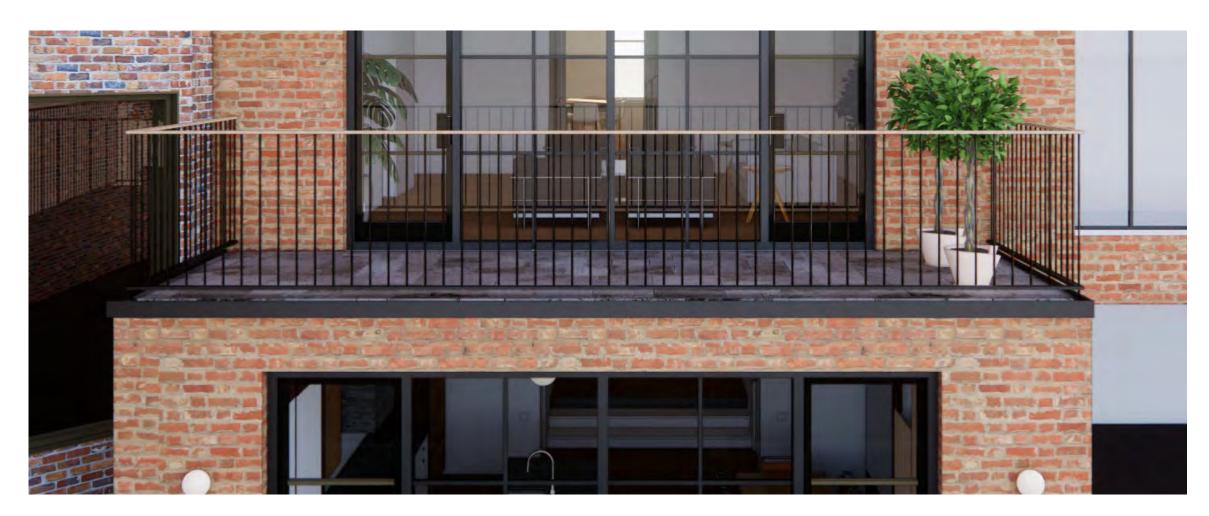
156 EAST 71 STREET

EXSISTING REAR FACADE CLOSE-UP PHOTOS

ZONING DISTRICT	R8B	BLOCK	1405
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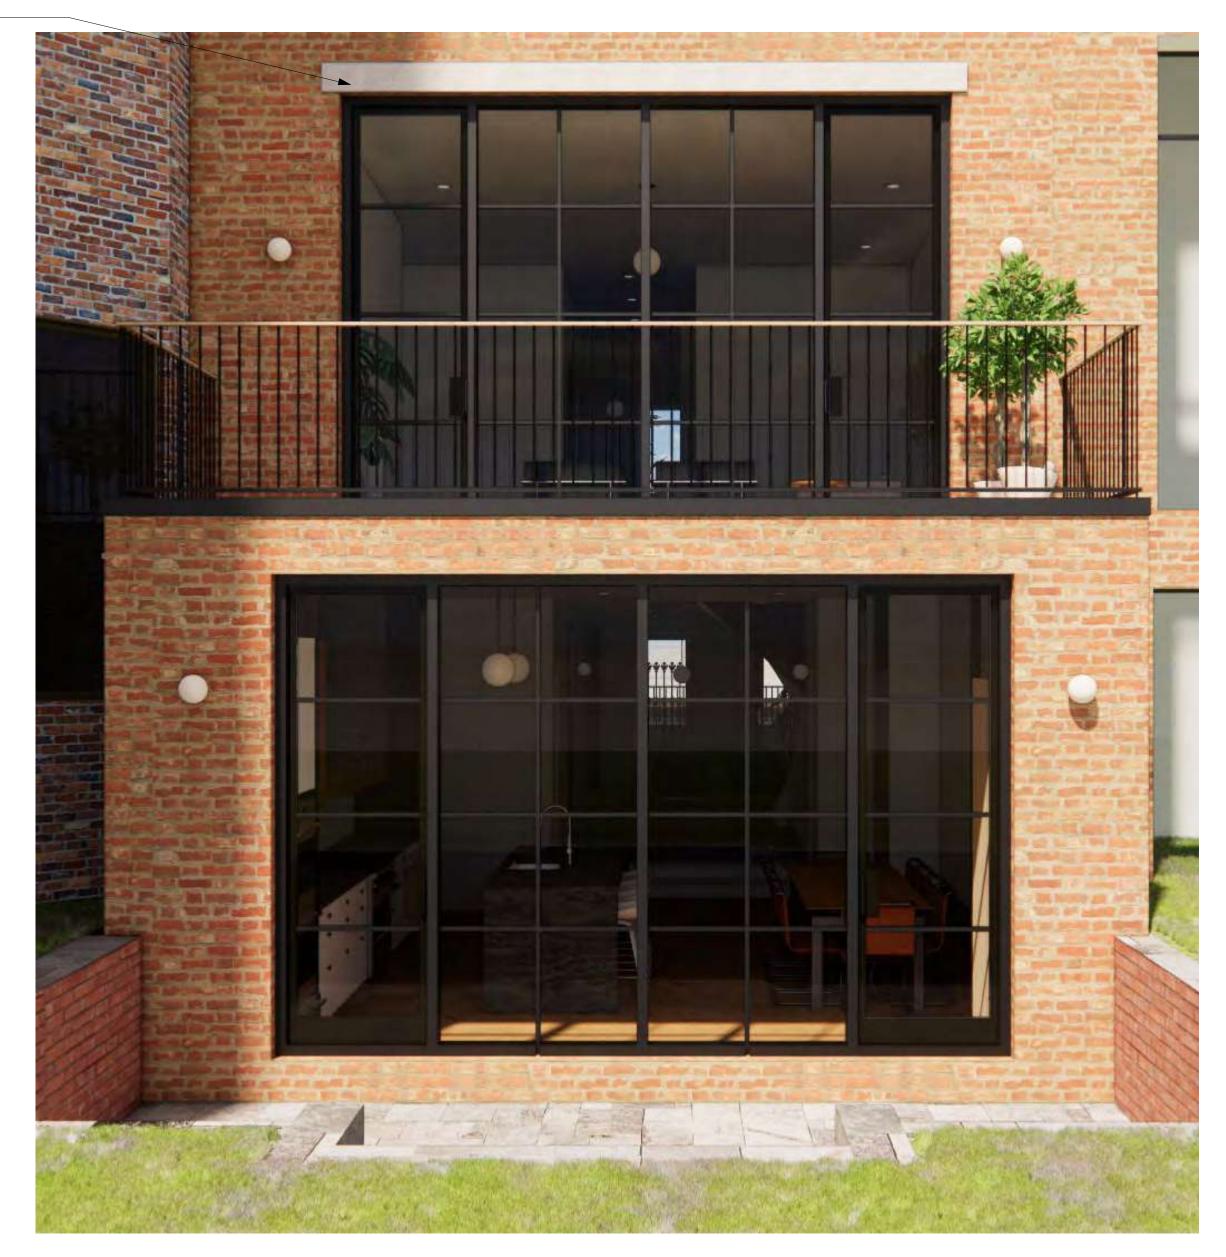


PROPOSED REAR FACADE



PROPOSED GUARDRAIL REAR EXTENSION

MATCH MATERIAL OF LINTEL WITH OTHER LINTELS



PROPOSED REAR EXTENSION

156 E 71 ST

156 EAST 71 STREET

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DOB APPLICATION NO.: B01026912-I1

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DATE	REVISION


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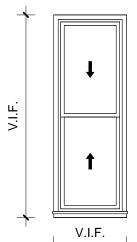
156 EAST 71 STREET


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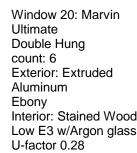
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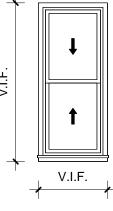
					WINDOW	V SCHEDULE							EXTE	RIOR DOOR SCHEDULE			
Mark	TYPE	Со	unt Width	Height	t Glass	Finish	U-Factor	SHGC	Door Number	Count	Description	Width	Height	Material	Finish	Fire Rating	U-Factor
10	DOUBLUE HUNG	3	2' - 8"	8' - 0"	Insulated - Low E3- Argon	EXTRUDED ALUMINUM CLAD PAINETD WOOD	0.28	0.19									
20	DOUBLUE HUNG	3	2' - 8"	6' - 9"	Insulated - Low E3- Argon	EXTRUDED ALUMINUM CLAD PAINETD WOOD	0.28	0.19	ED-01	1	Exiting Entry Door	3' - 4"	7' - 3"	Painted Wood with Window	Painted	N/A	N/A
21	DOUBLUE HUNG	3	2' - 6"	6' - 2"	Insulated - Low E3- Argon	EXTRUDED ALUMINUM CLAD PAINETD WOOD	0.28	0.19	ED-02	1	Exiting Entry Door	3' - 4"	7' - 3"	Painted Wood with Window	Painted	N/A	N/A
30	DOUBLUE HUNG	3	2' - 8"	5' - 9"	Insulated - Low E3- Argon	EXTRUDED ALUMINUM CLAD PAINETD WOOD	0.28	0.19	ED-03	2	Aluminum Glass Door	<varies></varies>	8' - 9"	Aluminum	Powder Coated	N/A	0.28
31	DOUBLUE HUNG	3	2' - 6"	5' - 9"	Insulated - Low E3- Argon	EXTRUDED ALUMINUM CLAD PAINETD WOOD	0.28	0.19	ED-10	2	Aluminum Glass Door	<varies></varies>	9' - 7"	Aluminum	Powder Coated	N/A	0.28
			1	1			-	1	ED-40	1	Aluminum Glass Door	2' - 6 3/8"	6' - 8 27/32	2" Aluminum	Powder Coated	N/A	0.28









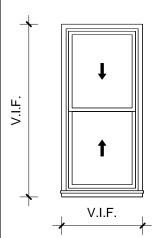


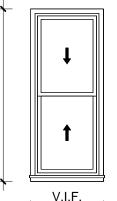


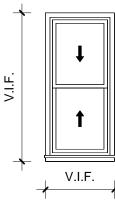



Link Unit with the second	Image: state of the state	Image: Window 20: Marvin Ultimate Double Hung count: 6 Image: Window 20: Marvin Ultimate Double Hung count: 6 Image: Window 21: Marvin Ultimate Double Hung count: 6 Startior: Extruded Aluminum Ebony Interior: Stained Wood Low E3 w/Argon glass U-factor 0.28 Image: Window 21: Marvin Ultimate Double Hung count: 6 Vi.F. Vi.F. Vi.F.	Door ED-01: Existing Entry Door count: 1 Exterior: Wood Painted Black Interior: Wood Painted Black Low E3 w/Argon glass U-factor N/A	Line view of the second	Glass Door count: 2 (as drawn and mirrored) Exterior: Extruded Aluminum Ebony Interior: Extruded Aluminum Ebony	as drawn and Extruded Ebony xtruded Ebony /Argon glass
Description Long Height Area Gase Stype Prest-Marcel U-Facor GM / Select Or Number Coli Description Weight Height Transverse Finish Prest-Marcel Bender Door 2 -8 6 -0 -1 Select Phatematice Prest-Marcel Bender Door 2 -8 6 -0 -1 Select Phatematice		Ultimate Double Hung count: 6 Exterior: Extruded Aluminum Ebony Interior: Stained Wood Low E3 w/Argon glass U-factor 0.28 Ultimate Double Hung count: 3 Exterior: Extruded Aluminum Ebony Interior: Stained Wood Low E3 w/Argon glass U-factor 0.28	Glass Door count: 1 Exterior: Extruded Aluminum Ebony Interior: Extruded Aluminum Ebony Low E3 w/Argon glass U-factor 0.28	δ Door ED-50: Exterior δ Door With Glass count: 1 Exterior: Extruded Aluminum Ebony Interior: Wood Painted White Low E3 w/Argon glass U-factor N/A U-factor N/A		
Col 1 Garder Bevalue Data 2 - 8" 6 - 2" 0" 1 - 344" PANTED NA G41 THERMALLY BROKEN STEEL WINDOW SYSTEM 13 - 0" 0" 64 - 40" 2 Intein Data 2 - 8" 6 - 2" 0" 1 - 344" PANTED NA G41 THERMALLY BROKEN STEEL WINDOW SYSTEM 13 - 0" 0" 5 - 3" 0" 1 - 344" PANTED NA G40 THERMALLY BROKEN STEEL WINDOW SYSTEM 14 - 0" 0" - 0" 10 - 0" 13 - 0" 0" 13 - 3" PANTED NA G81 THERMALLY BROKEN STEEL WINDOW SYSTEM 14 - 0" 0" - 0" 13 - 0" 0" 0" 0" 13 - 3" PANTED NA G81 THERMALLY BROKEN STEEL WINDOW SYSTEM 14 -0" 0" - 0" 12 - 0" 0"	CURTAIN WA	/ALL SCHEDULE		INTERIOR DOOR SCHEDU	ILE	
G10 THERMALLY BROKEN STEEL WINDOW SYSTEM 14 -0" 10 - 0" 140 SF Individ-Low E3-Agon POWDER COATED 0.28 0.19 C-03 1 Poked Door 2 - 6" 6 - 0" 0 - 1.34" PAINTED N/A G40 THERMALLY BROKEN STEEL WINDOW SYSTEM 14 - 4" 10 - 0" 140 SF Individ-Low E3-Agon POWDER COATED 0.28 0.19 C-44 2 1 Finder/Door 2 - 6" 6 - 0" 0 - 1.34" PAINTED N/A G40 THERMALLY BROKEN STEEL WINDOW SYSTEM 14 -4 0" 10 - 0" 12 SF Individ-Low E3-Agon POWDER COATED 0.28 0.19 BM-01 1 Giazd Elevator Door 2 - 6" 8 - 0" 0 - 1.34" PAINTED N/A G40 THERMALLY BROKEN STEEL WINDOW SYSTEM 14 -0" 10 - 0" 12 SF Individ-Low E3-Agon POWDER COATED 0.28 0.19 BM42 3 Interior Door 2 - 6" 8 - 0" 0 - 1.34" PAINTED N/A G4 THERMALLY BROKEN STEEL WINDOW SYSTEM 14 - 0.0" THERMALLY BROKEN STEEL WINDOW SYSTEM 14 - 0.0" N/A N/A N/A N/A N/A N/A N/A <t< th=""><th>Type MarkDescriptionLengthHeight</th><th>Area Glass Type Finish Material U-Factor CW SHGC CW</th><th></th><th></th><th></th><th>v</th></t<>	Type MarkDescriptionLengthHeight	Area Glass Type Finish Material U-Factor CW SHGC CW				v
G41 THERNALLY BROKEN STEEL WINDOW SYSTEM 01-8 0-1-4 P3-F Packade LW R8-Argon PMODER COATED 0.28 0.19 C.44 2 Invition Door 2-8* 0-3 0-134/- PAINTED NAA G61 THERNALLY BROKEN STEEL WINDOW SYSTEM 10-0* 12-8* 0-1 0.10 C.44 2 Invition Door 2-8* 0-3 0-1 34/- PAINTED NAA G61 THERNALLY BROKEN STEEL WINDOW SYSTEM 14-0* 10-0* 12-8 0.19 PAIA Relation Door 2-6* 8-0* 0-1<34/-		140 SE Insulated Low E2 Argon DOWDED COATED 0.29 0.40				
GA0 THERNALLY BROKEN STEEL WINDOW SYSTEM 14 - 4 11*0 ¹ 7.1272*1 10.25 Inulated - Low E3-Agon POWDER COATED 0.28 0.19 BM-01 1 Glazde Elwator Door 2-8° 8 -0° 0.134* PANTED NA GB1 THERNALLY BROKEN STEEL WINDOW SYSTEM 14 - 0° 10 - 0° 120 SF Invalued - Low E3-Agon POWDER COATED 0.28 0.19 BM-02 11 Highir Poor 5-0° 8 -0° 0.134* PANTED NA 1 Glazde Elwator Door 2-8° 8'-0° 0.134* PANTED NA 1 Glazde Elwator Door 2-8° 8'-0° 0.134* PANTED NA 1 Glazde Elwator Door 2-8° 8'-0° 0.134* PANTED NA 10 Glazde Elwator Door 2-8° 8'-0° 0.134* PANTED NA 10 Glazde Elwator Door 2-8° 8'-0° 0.134* PANTED NA 10 Glazde Elwator Door 2-8° 8'-0° 0.134* PANTED NA 10 10.9 10.9 10.9 10.9 10.9 10.9						
GB1 IHERMALLY BROREN STELL WINDOW SYSTEM 14 - 0"						
N Site add 21; Terrardy boots water loss of add; Terrardy boot						
Image: Construction of the structure of the						
1 1				4' - 10" 8' - 0"		
N intervent operation of the system in t			1-01 1 Glazed Elevator Door	2' - 8" 8' - 0"	0' - 1 3/4" PAINTED	N/A
N Image: Courter Back Ima	Broken Steel Window System	Broken Steel Window System	1-02 1 Interior Door		0' - 1 3/4" PAINTED	
N Low Es wingon glass NA Pantrebo NA Later 0.28 NA Low Es wingon glass NA Pantrebo NA Later 0.28 NA Later 0.28 NA Pantrebo NA Later 0.28 NA Later 0.28 NA Pantrebo NA Later 0.28 NA Later 0.28 NA Pantrebo NA Later 0.28 NA Low Es wingon glass Low Es wingon glass <thlow es="" glas<="" th="" wingon=""> Low Es wingo</thlow>		Exterior: Powder Coated Black				
1 1	Low E3 w/Argon glass	The second secon				
14 - 3" 13 - 6" 13 - 4" 14 - 3" 13 - 6" 1 - 134" PAINTED N/A 14 - 3" <t< td=""><td></td><td></td><td></td><td></td><td></td><td></td></t<>						
10'-3' 13-6' 13-6' 13-6' 2-06 2 Pockel Door 2'-4' 8'-0' 0'-13/4' PAINTED N/A 10'-3' 10'-3' 10'-3' 10'-3' 10'-3' 10'-3' PAINTED N/A 30'-2 10'-10'-0' 2'-8' 8'-0' 0'-13/4' PAINTED N/A 30'-2 10'-10'-0' 10'-10'-0' 3'-2' 8'-0' 0'-13/4' PAINTED N/A 30'-2 10'-10'-0'-0'-13'-10'-0' 10'-10'-0' 3'-2' 8'-0' 0'-13/4' PAINTED N/A 30'-2 2'-10'-10'-0'-0'-0'-13'-0'-0'-13/4' PAINTED N/A 10'-0'-0'-13/4' PAINTED N/A						
14-3* 14-3* 2-07 2 Full Glass Door 2'-4" 6'-0" 0'-0 1/2" GLASS N/A 14-3*						
Glass wall G40: Thermally Glass wall G40: Thermally Sold 1 Glasz Glazzd Elevator Door 2'-8' 8'-0' 0'-13/4' PAINTED N/A Sold 1 Interior Door 2'-8' 8'-0' 0'-13/4' PAINTED N/A Sold 1 Pocket Door 2'-8' 8'-0' 0'-13/4' PAINTED N/A Sold 1 Pocket Door 2'-8' 8'-0' 0'-13/4' PAINTED N/A Sold 1 Pocket Door 2'-8' 8'-0' 0'-13/4' PAINTED N/A Sold 1 Pocket Door 3'-2' 8'-0' 0'-13/4' PAINTED N/A Sold 1 Pocket Door 3'-2' 8'-0' 0'-13/4' PAINTED N/A Sold 1 Pocket Door 3'-0' 8'-0' 0'-13/4' PAINTED N/A Sold 1 Pocket Door 2'-8' 8'-0' 0'-13/4' PAINTED N/A Sold 1 Pocket Door 2'-8' 8'-0' 0'-13/4' PAINTED N/A Sold </td <td>14' - 3"</td> <td></td> <td></td> <td></td> <td></td> <td></td>	14' - 3"					
Image: Section of the sectio	*					
Broken Steel Window System Back 3-04 2 Interior Door 2'-8" 8'-0" 0'-13/4" PAINTED N/A Image: Steel Window System Back Interior Door 3'-0" 8'-0" 0'-13/4" PAINTED N/A Image: Steel Window System Back Image: Steel Window System Back 1 Pocket Door 3'-0" 8'-0" 0'-13/4" PAINTED N/A Image: Steel Window System Back Image: Steel Window System Back 1 Pocket Door 3'-0" 8'-0" 0'-13/4" PAINTED N/A Image: Steel Window System Back Image: Steel Window System Back 1 Pocket Door 3'-0" 8'-0" 0'-13/4" PAINTED N/A Image: Steel Window System Back Image: Steel Window System Back 1 Pocket Door 2'-4" 8'-0" 0'-13/4" PAINTED N/A Image: Steel Window System Back Image: Steel Window System Back 1 Image: Steel Window System Back N/A 1 Image: Steel Window System Back N/A N/A N/A N/A Image: Steel Window System Back Image: Steel Window System Back Image: Steel Window System Back 1 Image: Steel Windo			3-02 1 Interior Door	2' - 6" 8' - 0"	0' - 1 3/4" PAINTED	N/A
Image: Second						
Image: Double Signed Field		Exterior: Powder Coated Black				
Ufactor 0.28 3-06 1 Pocket Door 3-0° 8'-0° 0'-13/4° PAINTED N/A 3-07 2 Pocket Door 2'-4° 8'-0° 0'-13/4° PAINTED N/A 3-07 2 Pocket Door 2'-4° 8'-0° 0'-13/4° PAINTED N/A 4-01 1 Glazed Elevator Door 2'-8° 8'-0° 0'-13/4° PAINTED N/A 4-02 2 Pocket Door 3'-0° 8'-0° 0'-13/4° PAINTED N/A 4-03 1 Interior Door 2'-8° 8'-0° 0'-13/4° PAINTED N/A 4-04 2 Closet Door 3'-0° 8'-0° 0'-13/4° PAINTED N/A 4-04 2 Closet Door 5'-0° 8'-0° 0'-13/4° PAINTED N/A 4-04 2 Closet Door 5'-0° 8'-0° 0'-13/4° PAINTED N/A 4-04 2 Closet Door 5'-0° 8'-0° 0'-1						
307 2 Pocket boor 214 810 0113/4 PAINTED N/A 4-01 1 Glazed Elevator Door 2'-8" 8'-0" 0'-13/4" PAINTED N/A 4-02 2 Pocket Door 3'-0" 8'-0" 0'-13/4" PAINTED N/A 4-03 1 Interior Door 2'-0" 8'-0" 0'-13/4" PAINTED N/A 4-04 2 Closet Door 5'-0" 8'-0" 0'-13/4" PAINTED N/A 4-04 2 Closet Door 5'-0" 8'-0" 0'-13/4" PAINTED N/A 4-04 1 Interior Door 2'-0" 8'-0" 0'-13/4" PAINTED N/A 4-04 2 Closet Door 5'-0" 8'-0" 0'-13/4" PAINTED N/A 4-04 1 Interior Door 2'-8" 8'-0" 0'-13/4" PAINTED N/A 4-04 1 Interior Door 2'-8" 8'-0" 0'-13/4" PAINTED N/A	=					
4-02 2 Pocket Door 3' - 0" 8' - 0" 0' - 1 3/4" PAINTED N/A 4-03 1 Interior Door 2' - 0" 8' - 0" 0' - 1 3/4" PAINTED N/A 4-04 2 Closet Door 5' - 0" 8' - 0" 0' - 1 3/4" PAINTED N/A 4-05 1 Interior Door 2' - 8" 8' - 0" 0' - 1 3/4" PAINTED N/A 4-06 1 Interior Door 2' - 8" 8' - 0" 0' - 1 3/4" PAINTED N/A						
4-03 1 Interior Door 2' - 0" 8' - 0" 0' - 1 3/8" PAINTED N/A 4-04 2 Closet Door 5' - 0" 8' - 0" 0' - 1 3/4" PAINTED N/A 4-05 1 Interior Door 2' - 8" 8' - 0" 0' - 1 3/4" PAINTED N/A 4.05 1 Interior Door 2' - 8" 8' - 0" 0' - 1 3/4" PAINTED N/A						IN/A
4-04 2 Closet Door 5' - 0" 8' - 0" 0' - 1 3/4" PAINTED N/A 4-05 1 Interior Door 2' - 8" 8' - 0" 0' - 1 3/4" PAINTED N/A 4.05 1 Interior Door 2' - 8" 8' - 0" 0' - 1 3/4" PAINTED N/A	้อ					ΝΙ/Δ
4-05 1 Interior Door 2' - 8" 8' - 0" 0' - 1 3/4" PAINTED N/A 4.05 1 Classet Door 4' - 10" 9' - 0" 0' - 1 3/4" DAINTED N/A	ο		4-02 2 Pocket Door	3' - 0" 8' - 0"	0' - 1 3/4" PAINTED	
	ō		4-022Pocket Door4-031Interior Door	3' - 0" 8' - 0" 2' - 0" 8' - 0"	0' - 1 3/4" PAINTED 0' - 1 3/8" PAINTED	N/A
	ō		4-022Pocket Door4-031Interior Door4-042Closet Door	3' - 0" 8' - 0" 2' - 0" 8' - 0" 5' - 0" 8' - 0"	0' - 1 3/4" PAINTED 0' - 1 3/8" PAINTED 0' - 1 3/4" PAINTED	N/A N/A

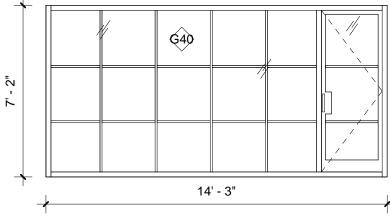

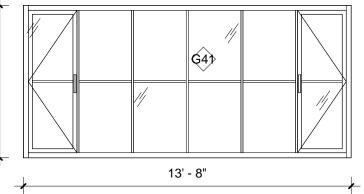


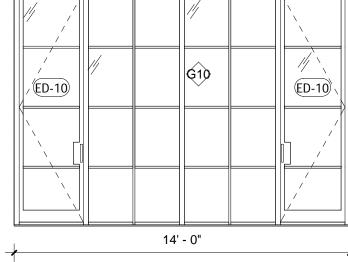


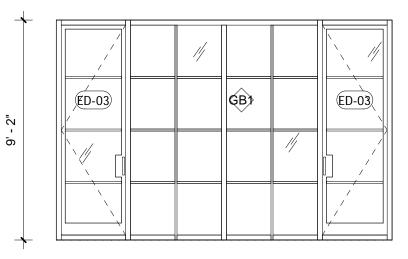

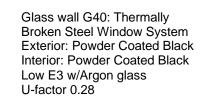




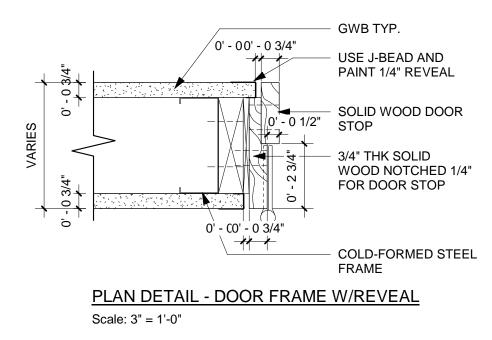

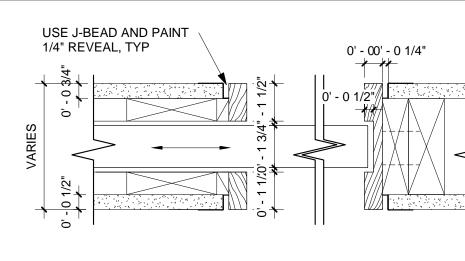

PLAN DETAIL - TYP. POCKET DOOR Scale: 3" = 1'-0"

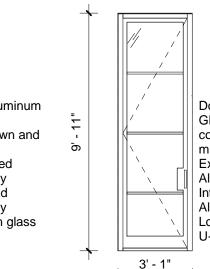

156 E 71 ST

New York, NY 10021

Architect

Daniel Kaplan, RA Bowerbird Architects, PLLC 124 9th Street, Suite 250 Brooklyn, NY 11215 Tel: 917.447.7855

Owner

156 E 71st St, New York, NY 10021

Code Consultant

Reuven Kalish reuven@professionalzoning.com

Structural Engineer

Aleksandr Yaker, PE Yaker Engineering, PC 1679 E 19th St., Ste 2A Brooklyn, NY 11229 Cell: (917) 518-2032 Fax: (718) 376-1283

Mechanical Engineer

Dmitry Levin, PE Levin Engineering PLLC 28 Dooley Street, 2nd Floor Brooklyn, NY 11235 Tel. (718) 332-2266

PRICING SET 01.06.2025

DOB EXAMINER - SEAL & SIGNATURE


DATE	REVISION

PROJECT

156 EAST 71 STREET

TITLE WINDOW- AND DOOR SCHEDULES AND TYPICAL DETAILS

ZONING DISTRICT	R8B	BLOCK	1405
ZONING MAP	8C	LOT	47
SEAL & SIGNATURE		DATE	01/06/2025
ED ARCI		JOB NO.:	147
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SEAL & SIGNATURE	2124	DRAWING NO .:	
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PROPOSED DOUBLE HUNG WINDOW DETAILS

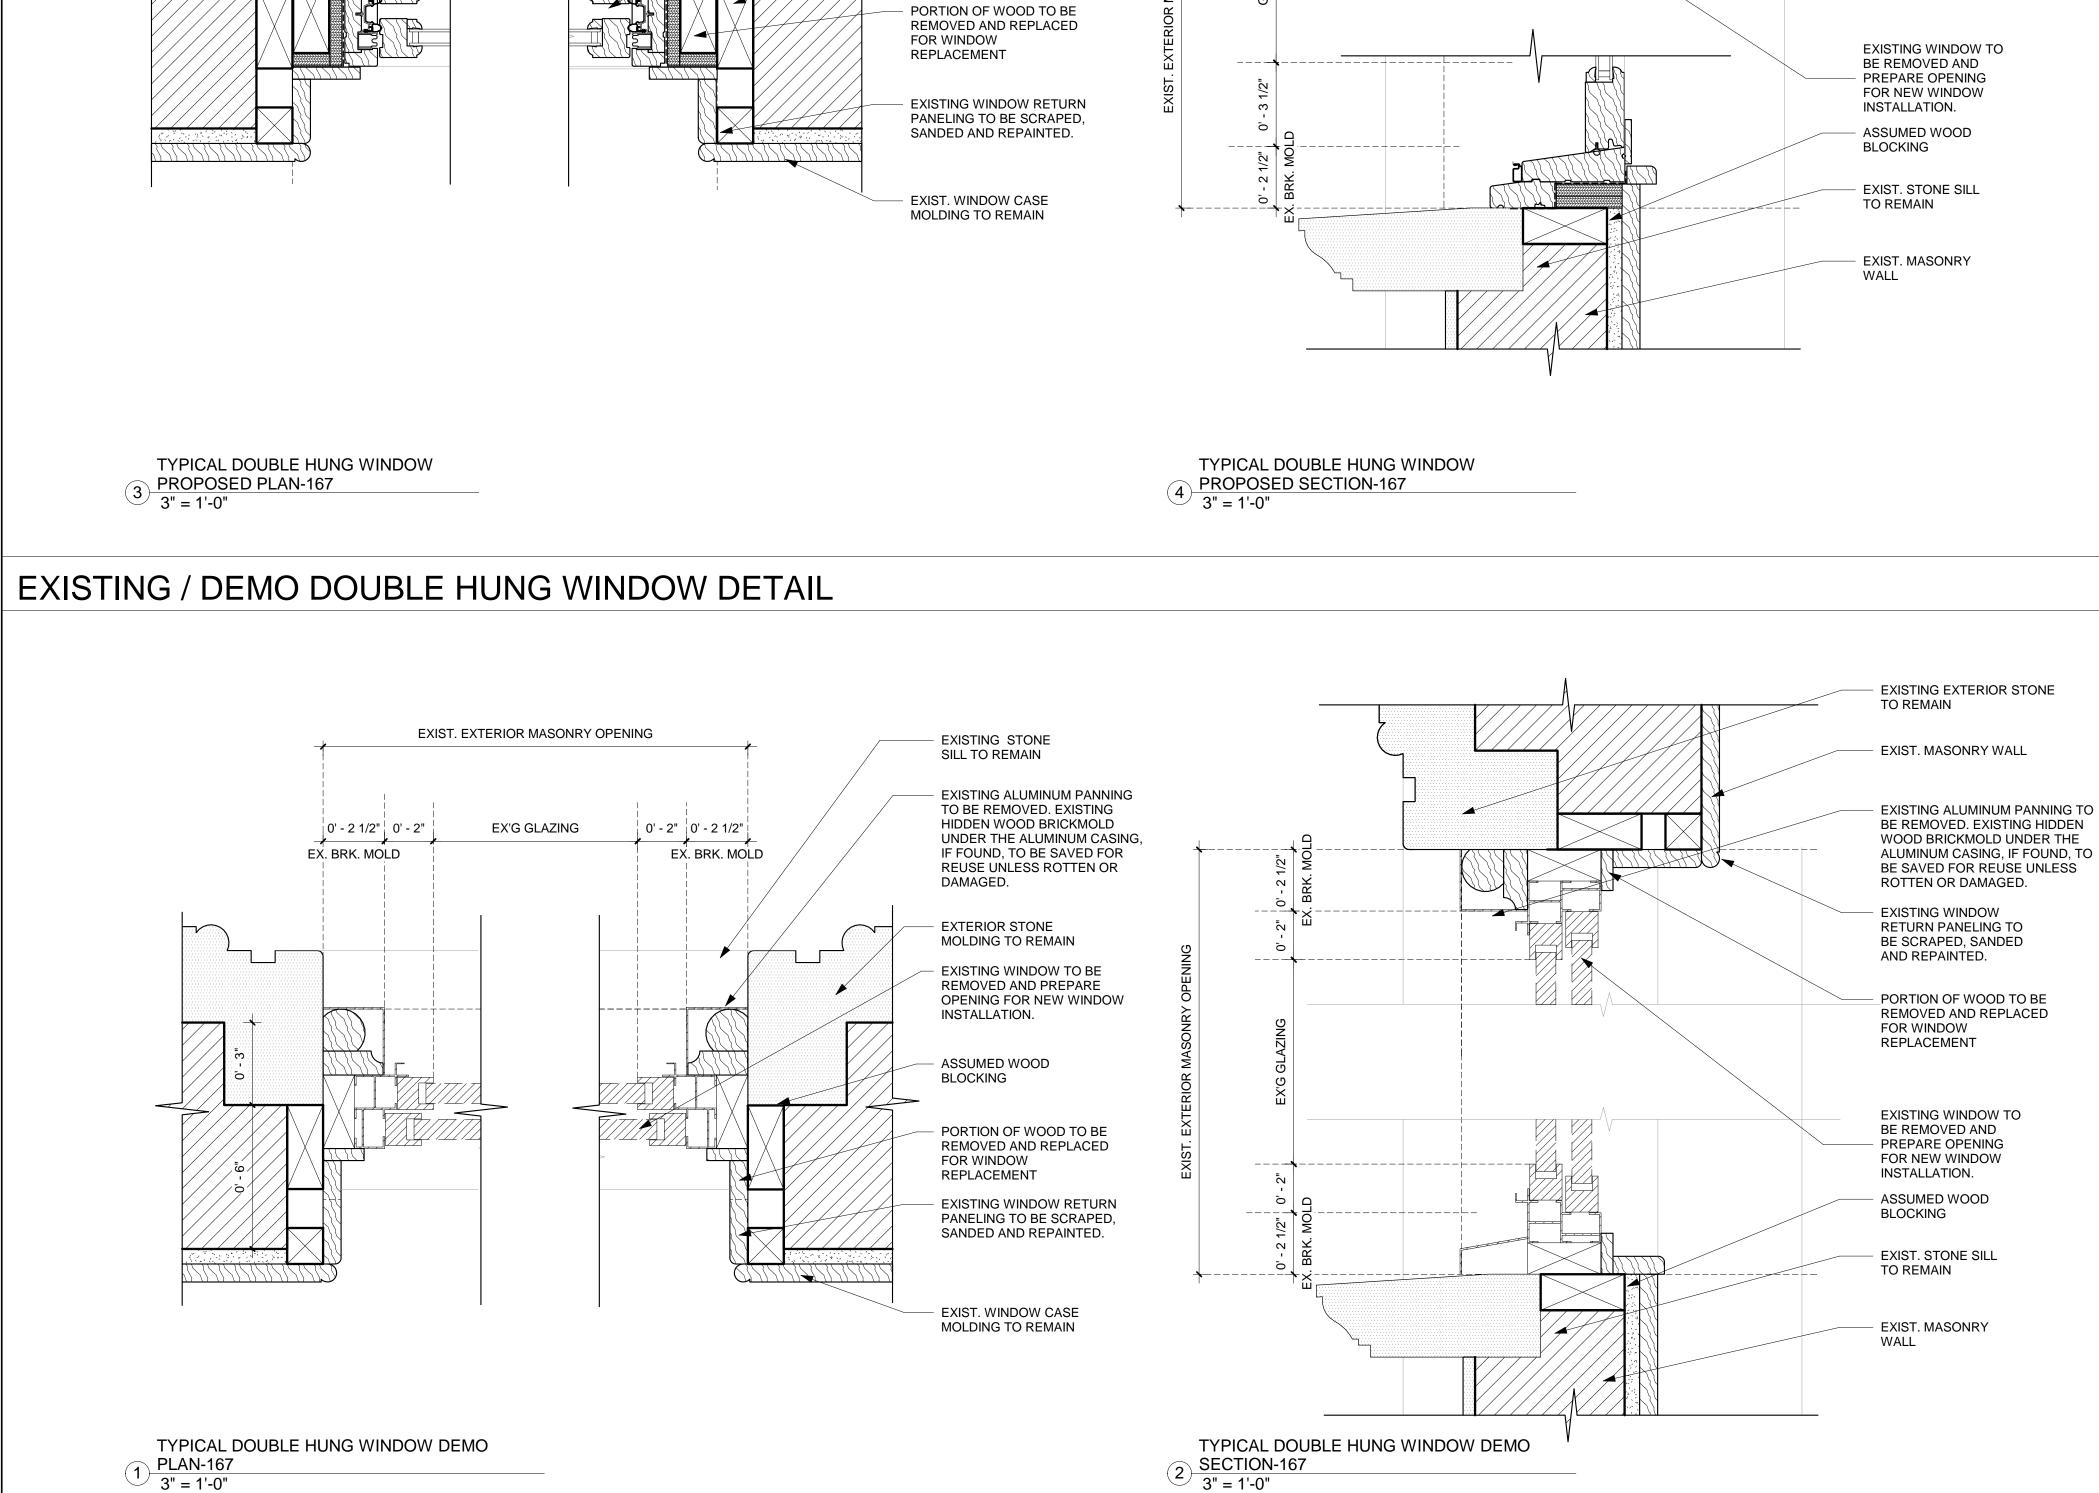0' - 2 1/2" 0' - 2"

EXIST. BRICK MOLD

EXIST. EXTERIOR MASONRY OPENING

GLAZING

0' - 2" 0' - 2 1/2"

EXIST. BRICK MOLD


EXISTING STONE SILL TO REMAIN

EXISTING HIDDEN WOOD BRICKMOLD OR NEW CUSTOM BRICKMOLD TO MATCH EXISTING PROFILE, PAINTED BLACK

EXTERIOR STONE MOLDING TO REMAIN REPLACED WOOD DOUBLE HUNG WINDOW (MARVIN OR APPROVED EQUAL), PAINTED

BLACK. VAPOR BARRIER (BLUESKIN SA OR APPROVED EQUAL)

ASSUMED WOOD BLOCKING

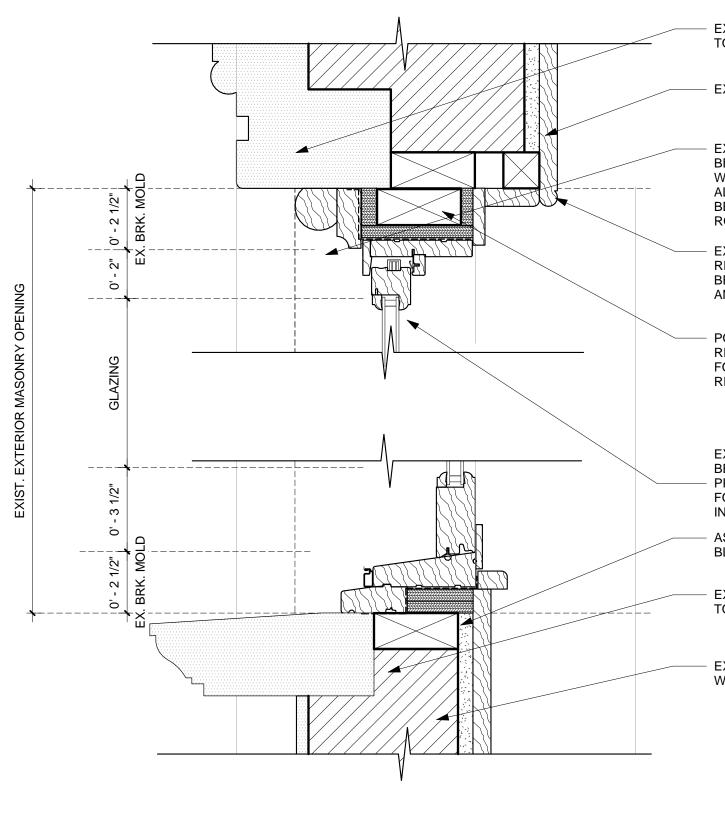

EXISTING EXTERIOR STONE


EXIST. MASONRY WALL

EXISTING ALUMINUM PANNING TO BE REMOVED. EXISTING HIDDEN WOOD BRICKMOLD UNDER THE ALUMINUM CASING, IF FOUND, TO BE SAVED FOR REUSE UNLESS ROTTEN OR DAMAGED.

EXISTING WINDOW RETURN PANELING TO BE SCRAPED, SANDED AND REPAINTED.

PORTION OF WOOD TO BE REMOVED AND REPLACED FOR WINDOW REPLACEMENT

EXAMPLE BRICK MOLD

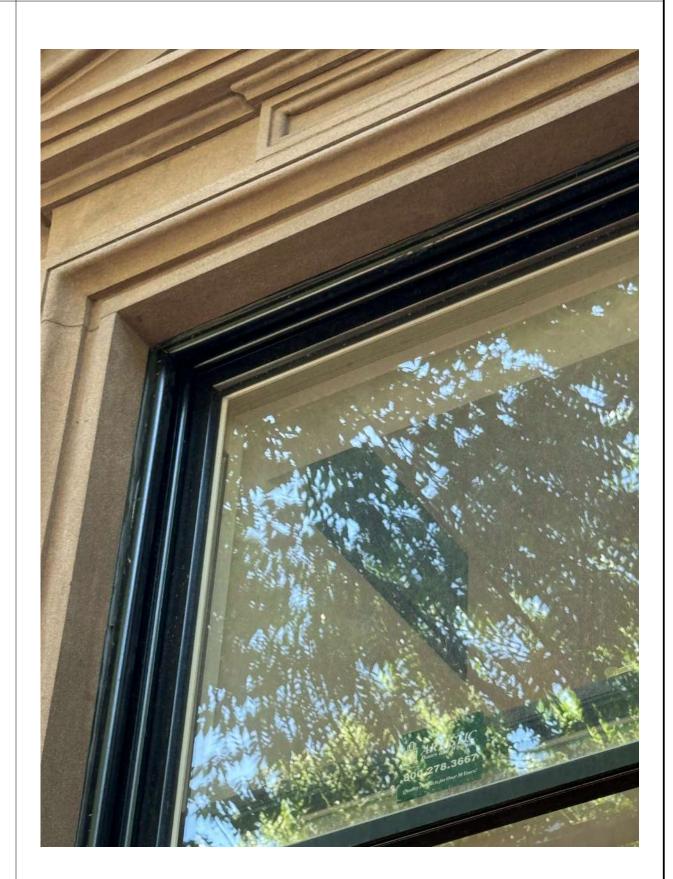



PICTURES TAKEN AT 152 EAST 71ST STREET WITH SIMILAR NEW BRICKMOLD AS PROPOSED

156 E 71 ST

156 EAST 71 STREET

Architect

Daniel Kaplan, RA Bowerbird Architects, PLLC 124 9th St. Suite 250 Brooklyn NY 11215 Tel: 917.447.7855

Owner

Steel Property Group

Code Consultant

Reuven Kalish reuven@professionalzoning.com

Structural Engineer

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MEP Engineer

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LANDMARKS SUBMISSION 01/06/2025

DOB APPLICATION NO.: B01026912-I1

DOB EXAMINER - SEAL & SIGNATURE

DATE	REVISION
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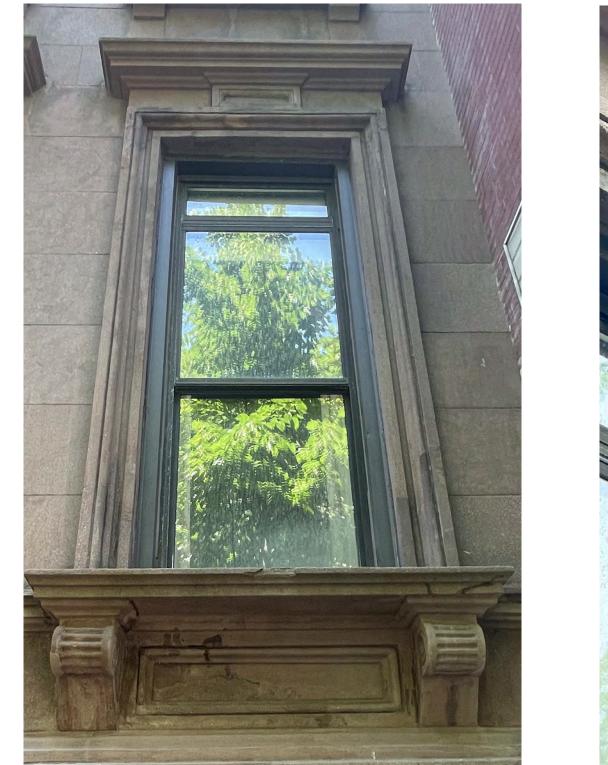
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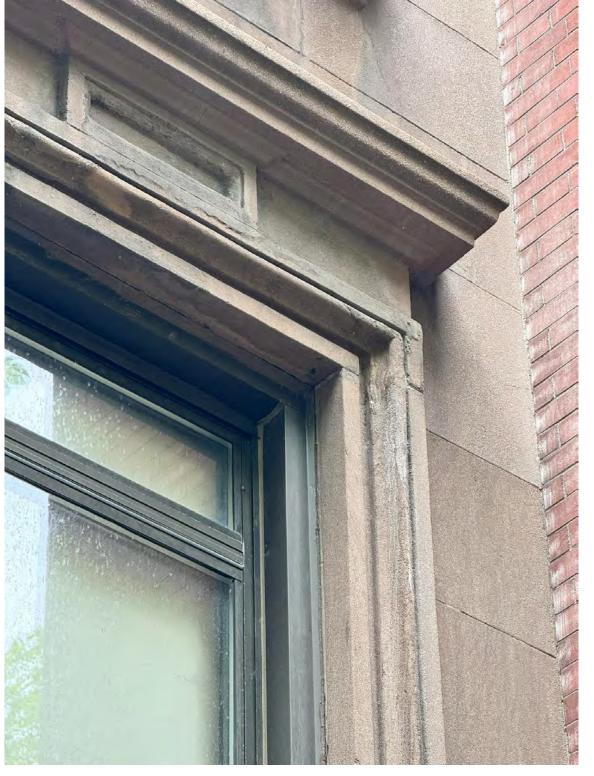
156 EAST 71 STREET

TITLE TYPICAL WINDOW DETAILS

ZONING DISTRICT	R8B	BLOCK	1405
	8C	LOT	47
SEAL & SIGNATURE		DATE	07/31/24
DARCI	\ \	JOB NO.:	0147
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FIRST FLOOR DOUBLE HUNG WINDOW CLOSE UP PHOTOS







BASEMENT DOUBLE HUNG WINDOW & EXISTING UNIT ENTRANCES

REMOVEEXISTING WRITING ON DOOR.



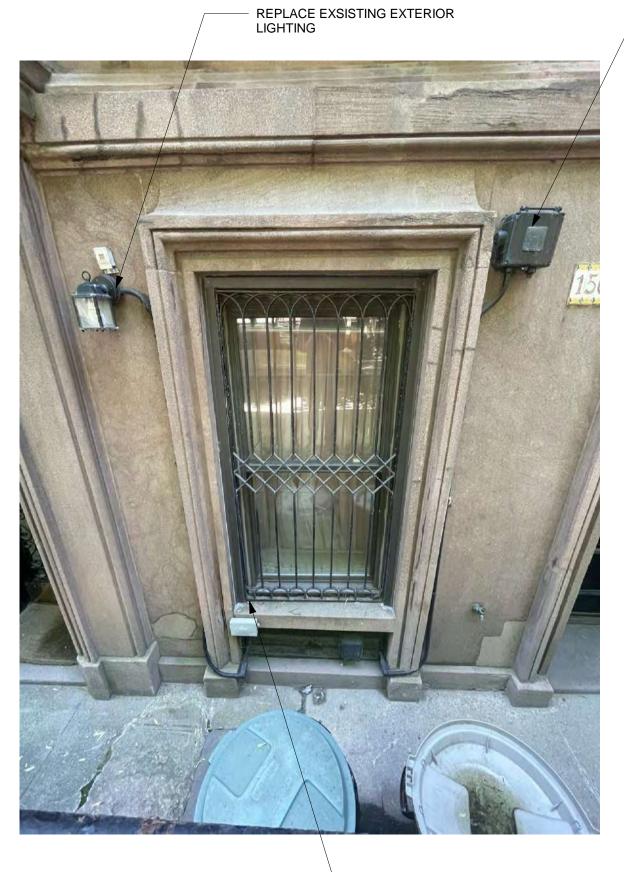


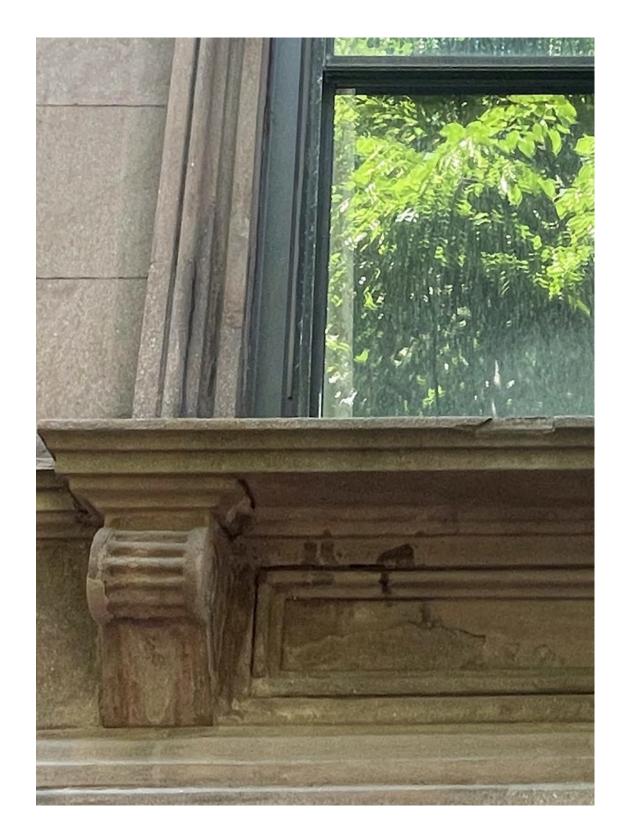



REMOVE ELECTRICAL BOX

EXISTING HIDDEN WOOD BRICKMOLD UNDER THE ALUMINUM CASING TO BE SAVED FOR REUSE UNLESS ROTTEN OR DAMAGED.

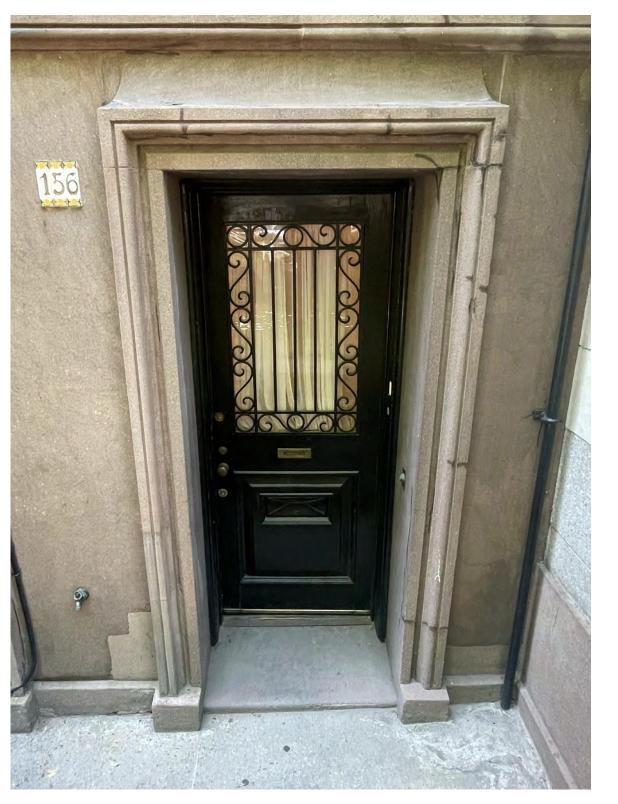



KEEP EX'G WINDOW GUARD @ BASEMENT WINDOW

156 E 71 ST

156 EAST 71 STREET

Architect

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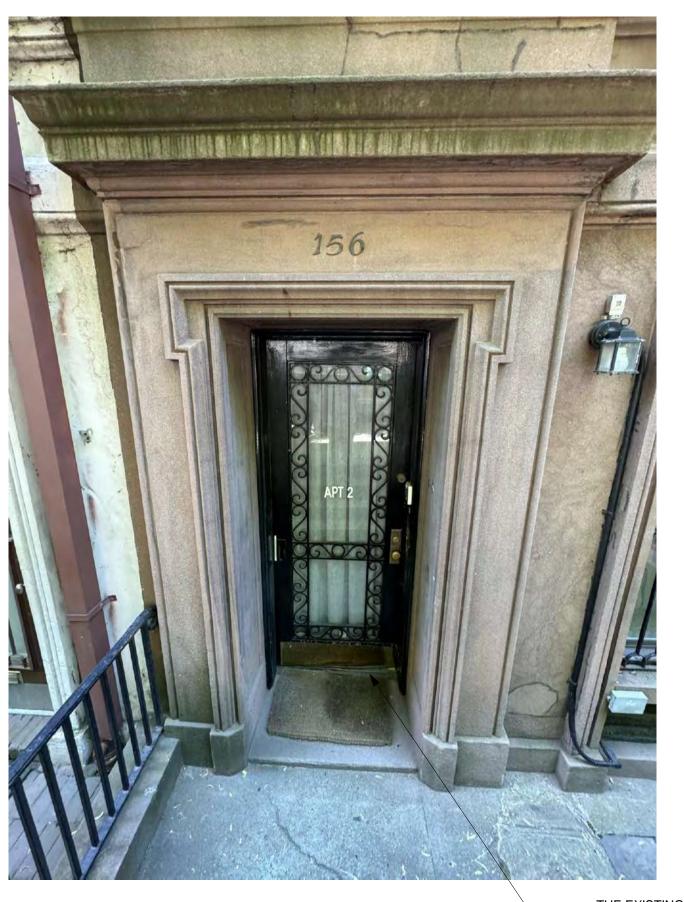
DATE	REVISION

PROJECT


156 EAST 71 STREET



ZONING DISTRICT	R8B	BLOCK	1405
ZONING MAP	8C	LOT	47
		DATE	07/31/24
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- THE EXISTING SECONDARY ENTRANCE DOOR WILL REMAIN AND BE REPAIRED BUT WILL FUNCTION AS A WINDOW RATHER THAN AS A DOOR.




EXISTING LIGHT TO BE REPLACED AND CONDUIT TO BE REROUTED IN THE WALL

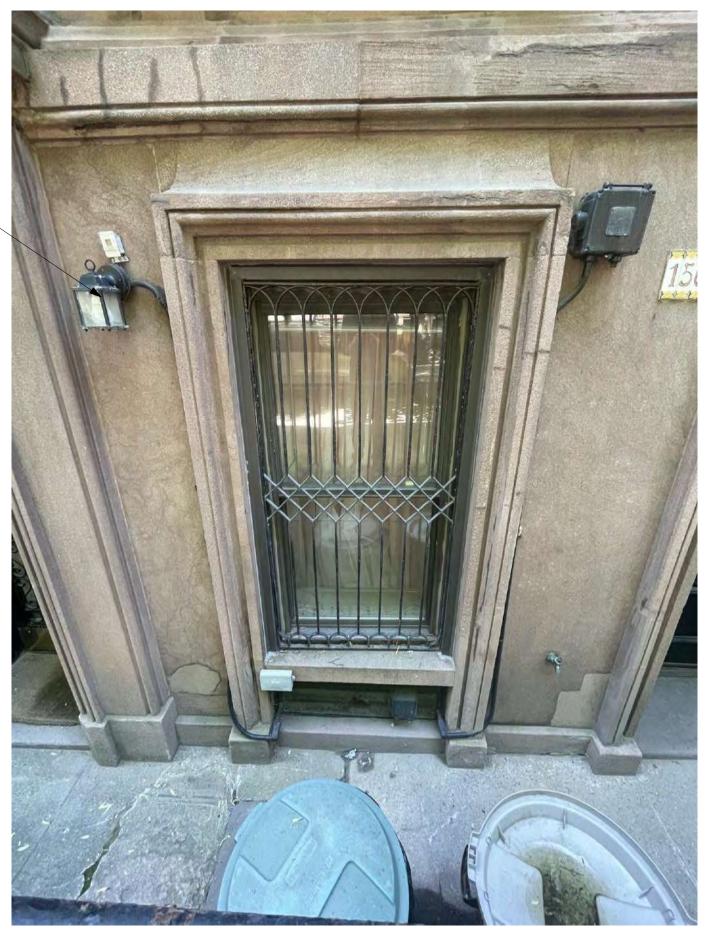





EX ENTRY DOOR TO REMAIN AND BE USED AS THE PRIMARY ENTRANCE

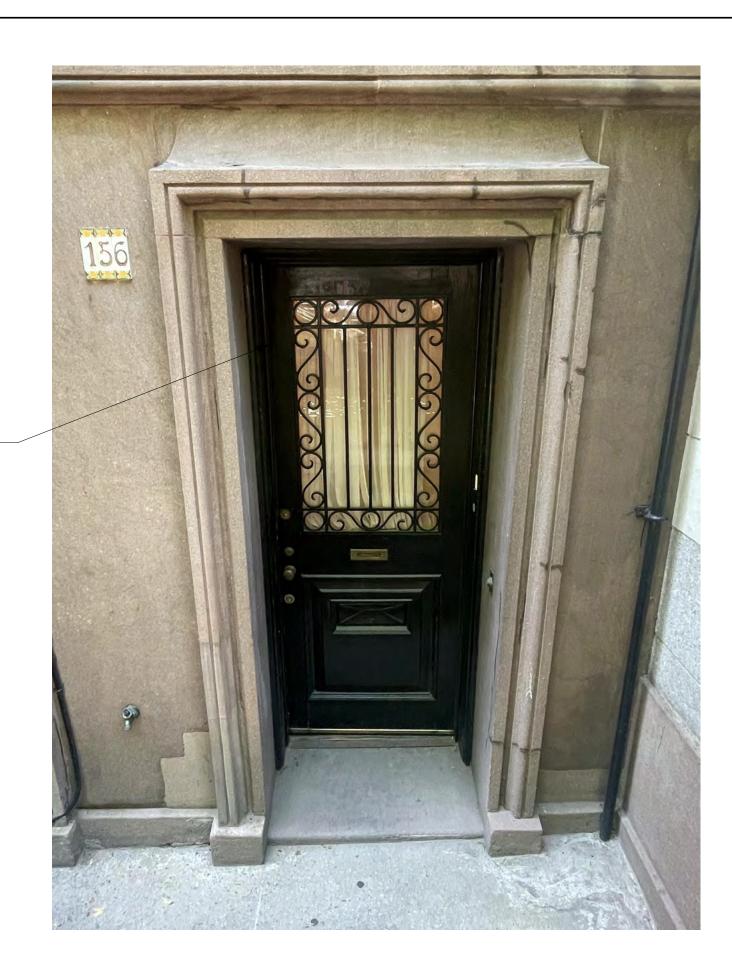



156 E 71 ST

156 EAST 71 STREET

Architect

Daniel Kaplan, RA Bowerbird Architects, PLLC 124 9th St. Suite 250 Brooklyn NY 11215 Tel: 917.447.7855

Owner

Steel Property Group

Code Consultant

Reuven Kalish reuven@professionalzoning.com

Structural Engineer

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MEP Engineer

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DOB APPLICATION NO.: B01026912-I1

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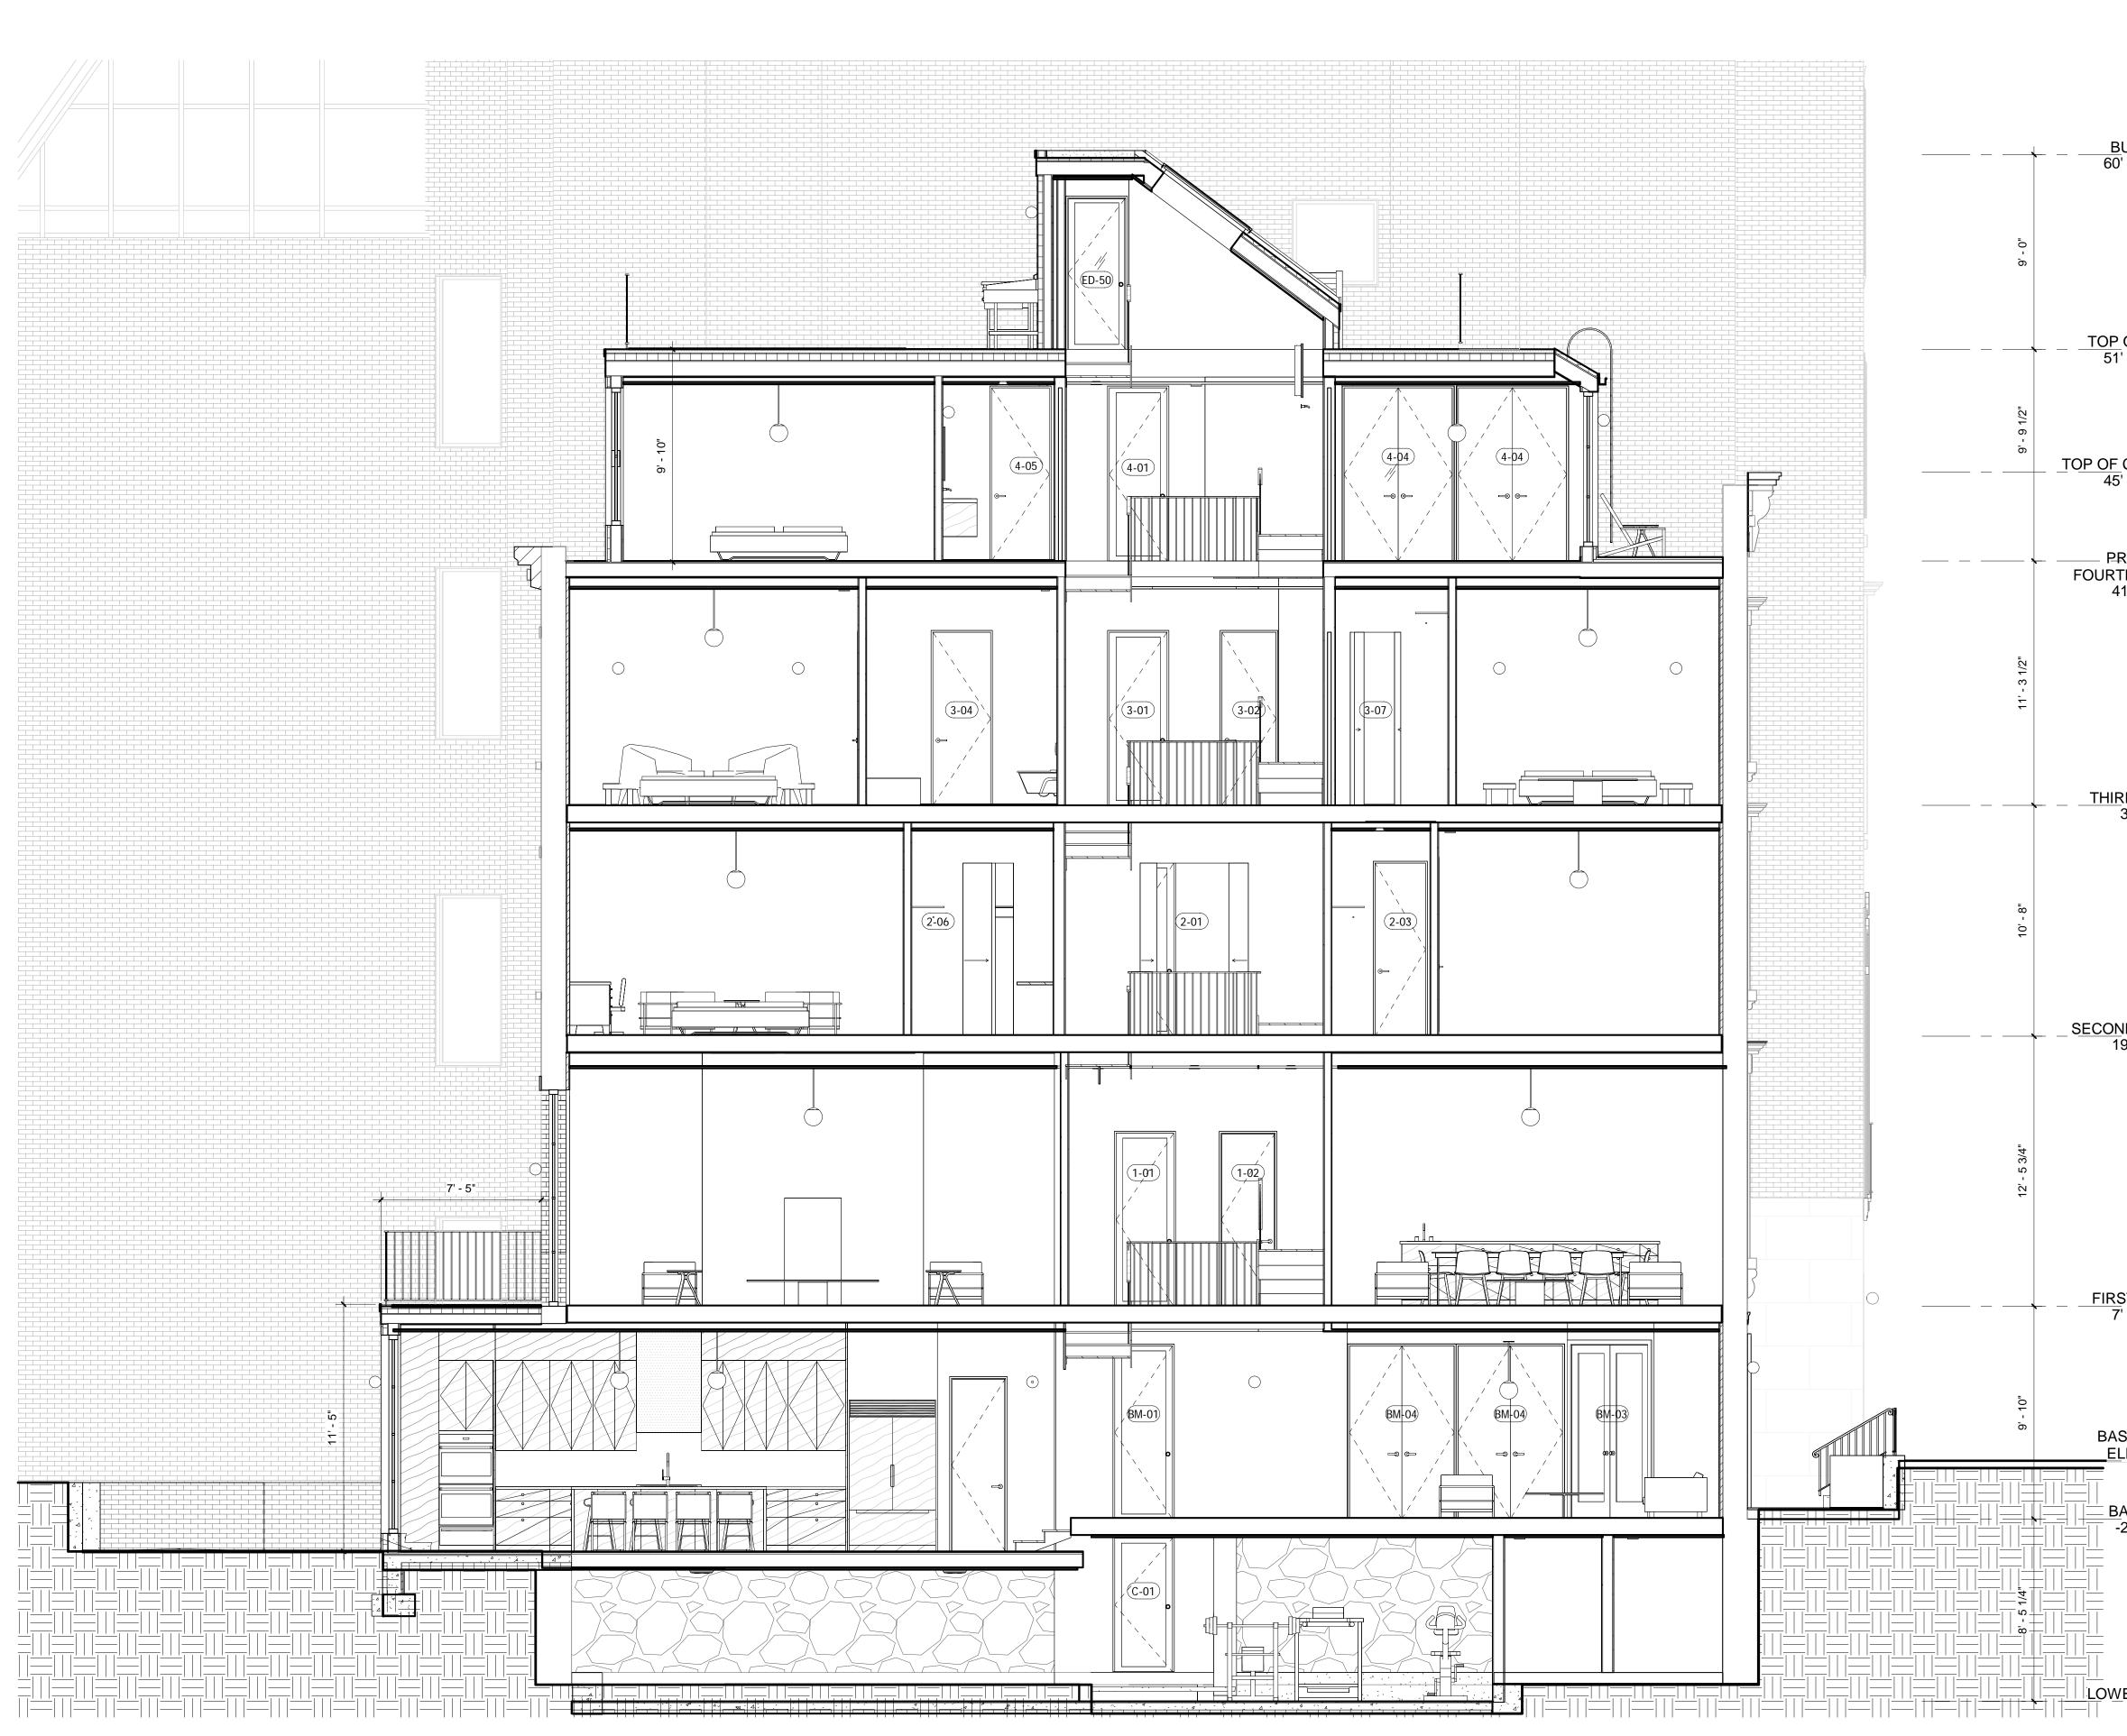
PROJECT

156 EAST 71 STREET


EXSISTING FRONT FACADE ENTRY DOOR CLOSE-UP PHOTOS

ZONING DISTRICT	R8B	BLOCK	1405
ZONING MAP	8C	LOT	47
SEAL & SIGNATURE		DATE	07/31/24
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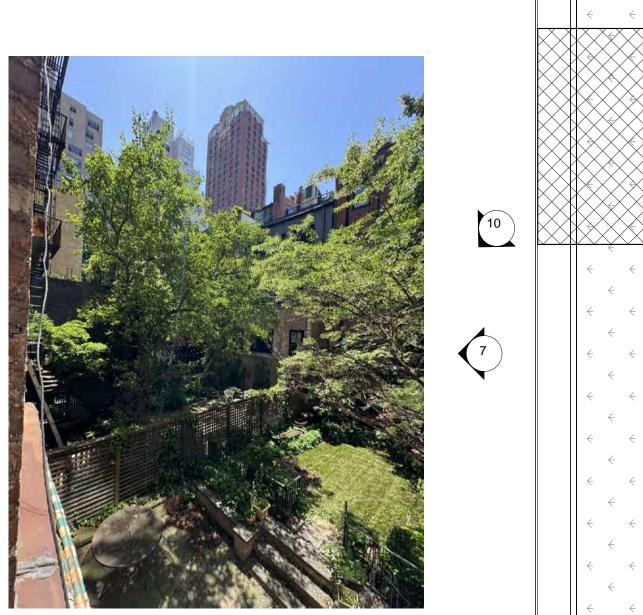
$1 \frac{\text{LONGITUDINAL SECTION - PROPOSED}}{1/4" = 1'-0"}$



	156 E 71 ST
	156 EAST 71 STREET
	Architect
TOP OF	Daniel Kaplan, RA
BULKHEAD 60' - 4 17/32"	Bowerbird Architects, PLLC 124 9th St. Suite 250
00 - + 17/32	Brooklyn NY 11215
	Tel: 917.447.7855
	Owner
	Steel Property Group
<u>OP OF ROOF</u> 51' - 4 17/32"	
	Code Consultant
	Reuven Kalish
	reuven@professionalzoning.com
45' - 8 15/32"	
PROPOSED	Structural Engineer
JRTH FLOQR 41' - 7 5/32"	Aleksandr Yaker, PE
11 1 0,02	Yaker Engineering, PC 1679 E 19th St., Ste 2A
	Brooklyn, NY 11229
	Cell: (917) 518-2032 Fax: (718) 376-1283
	MEP Engineer
	Dmitry Levin, PE
	Levin Engineering PLLC
	28 Dooley Street, 2nd Floor
HIRD FLOOR 30' - 3 5/8"	Brooklyn, NY 11235
	Tel. (718) 332-2266
	01/06/2025 DOB APPLICATION NO.: B01026912-I1 DOB EXAMINER - SEAL & SIGNATURE
19' - 7 9/16"	
	DATE REVISION
	PROJECT
	156 EAST 71 STREET
IRST FLOOR 7' - 1 25/32"	130 LAGT / I STREET
	TITLE
	PROPOSED BUILDING
	SECTION
ELEVATION 0'-0"	
-	
BASEMENT -2' - 8 7/32"	
-2 - 0 1/32 -	
	ZONING DISTRICT R8B BLOCK 1405
-	ZONING MAP8CLOT47SEAL & SIGNATUREDATE07/31/24
	JOB NO.: 0147
PRORPOSED	CONTEL: NO NO NO NO
$\frac{DWERED CELLAR}{-11' - 1 3/8"} $	DRAWING NO.:
-11' - 1 3/8" 🔎	L-301.00
	© BOWERBIRD ARCHITECTS 2024 - DO NOT SCALE FROM DRAWINGS



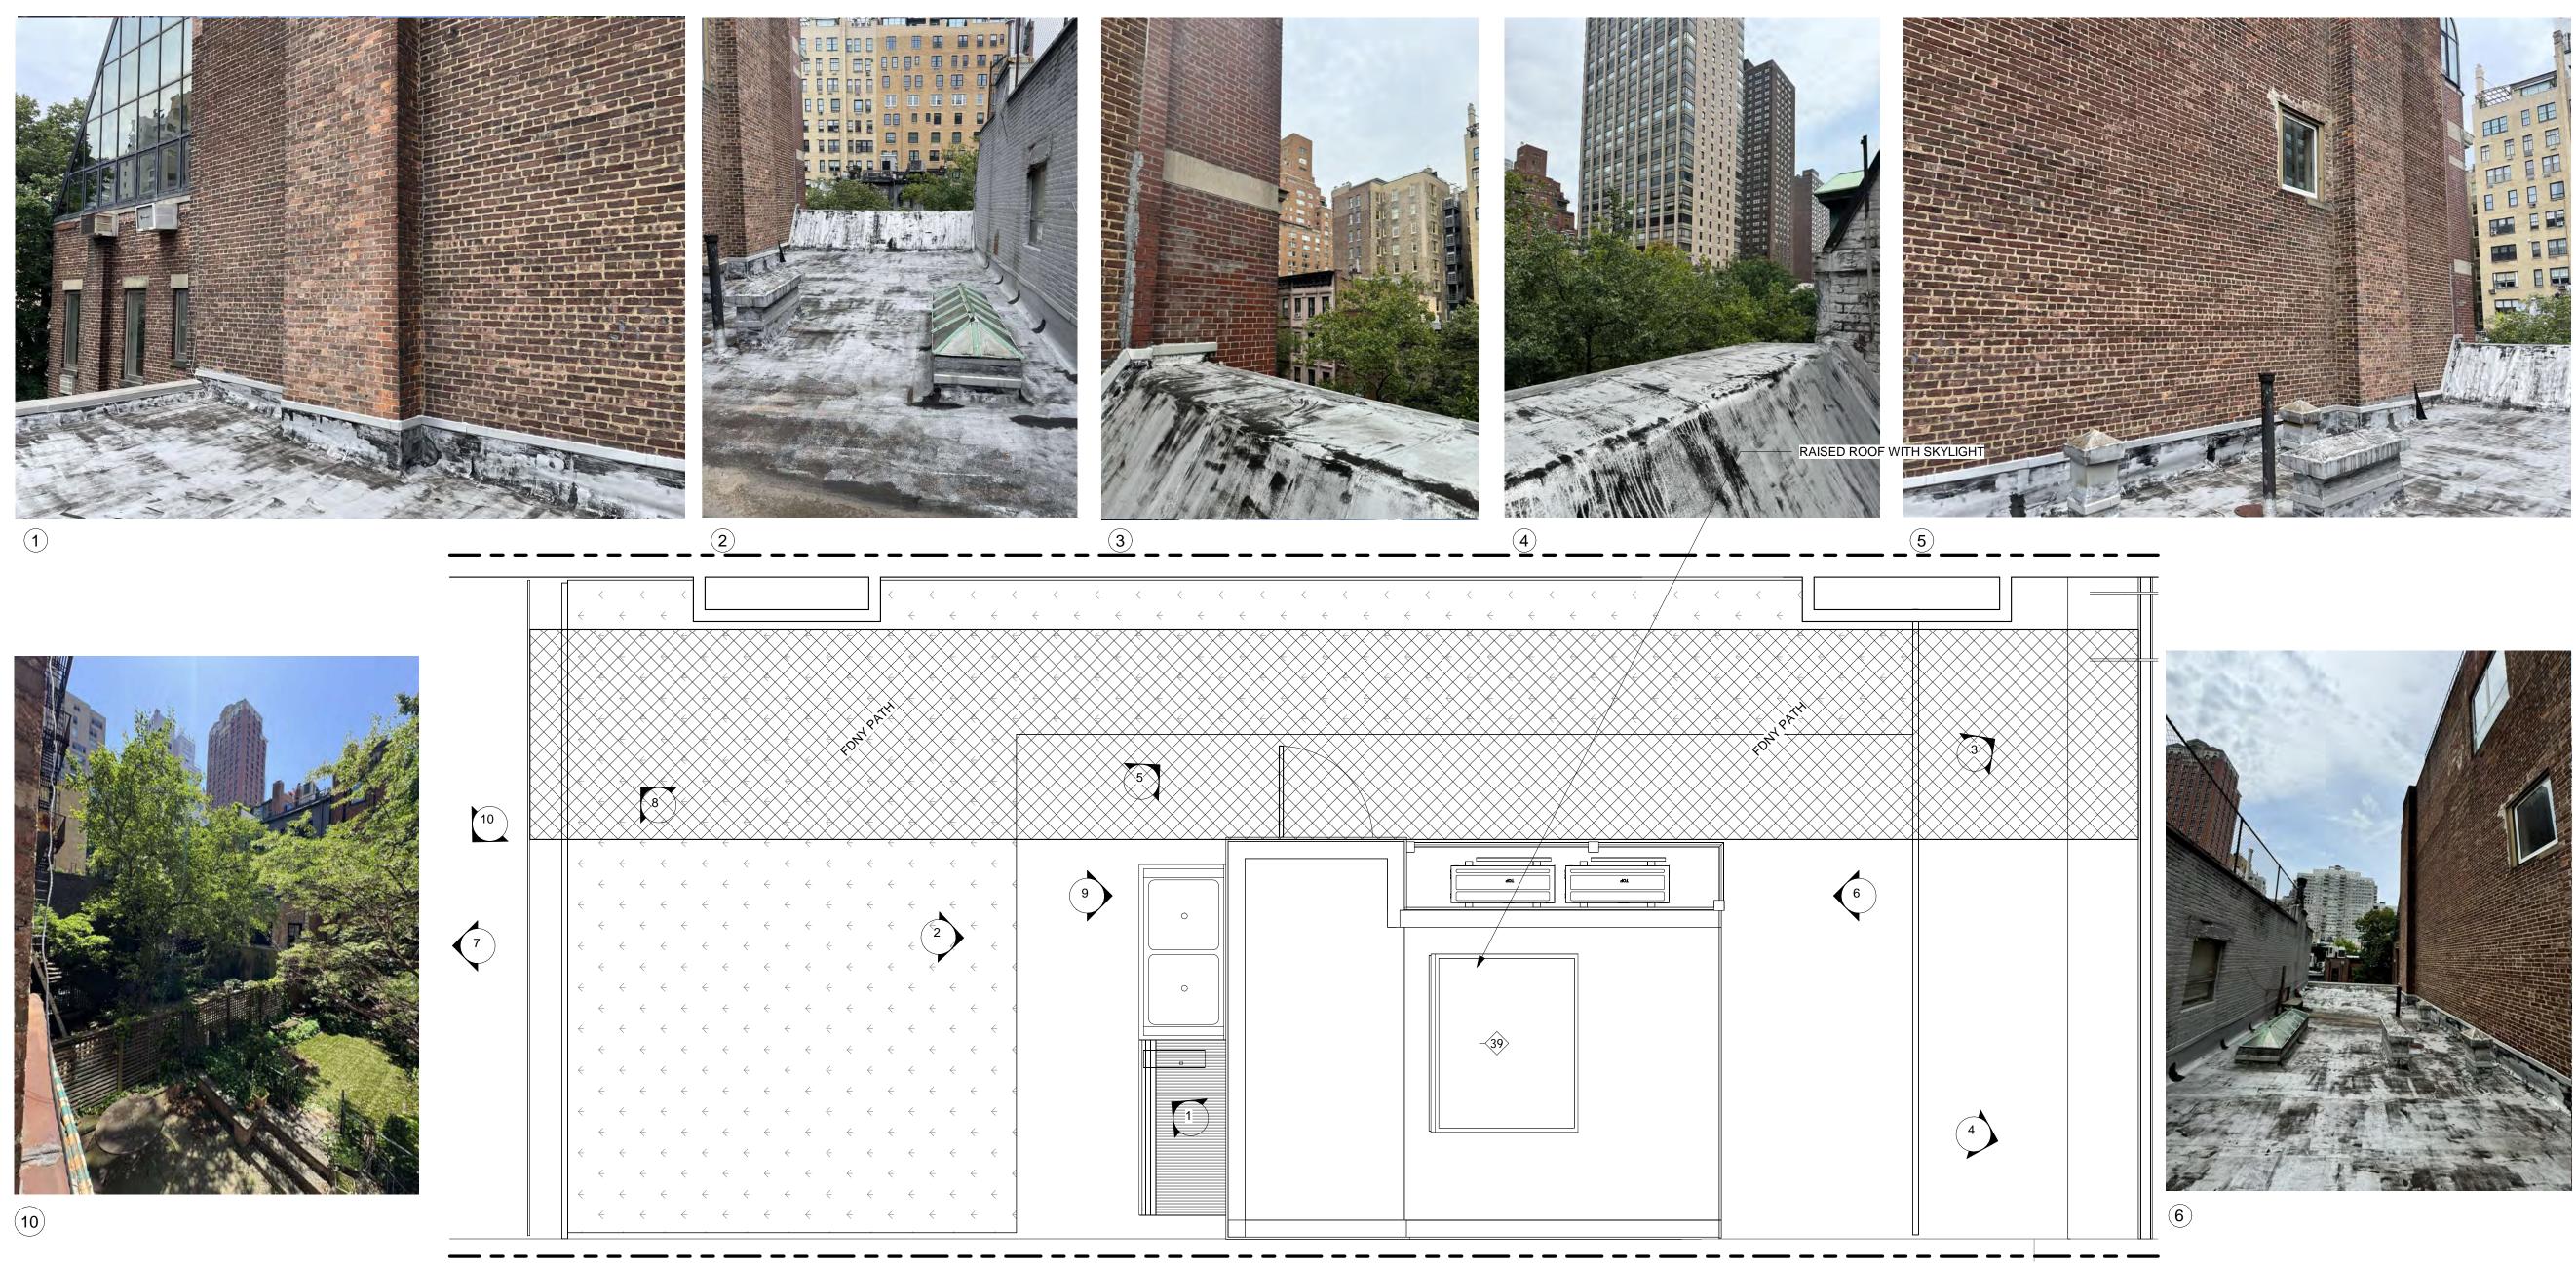






(9)

PROPOSED ROOF PLAN





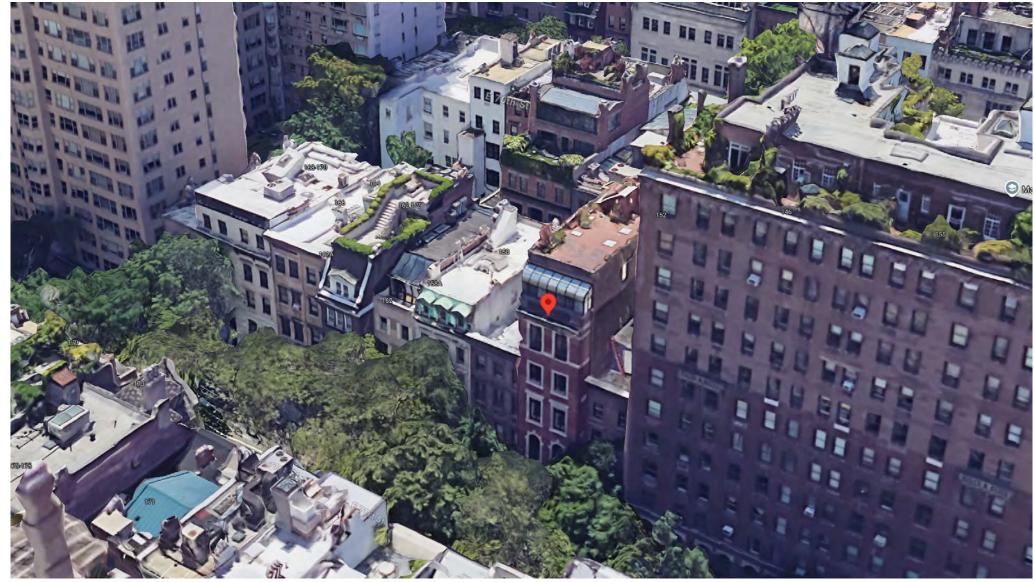

ARIEL VIEW

156 E 71 ST

156 EAST 71 STREET

Architect

Daniel Kaplan, RA Bowerbird Architects, PLLC 124 9th St. Suite 250 Brooklyn NY 11215 Tel: 917.447.7855

Owner

Steel Property Group

Code Consultant

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Structural Engineer

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DOB APPLICATION NO.: B01026912-I1

DOB EXAMINER - SEAL & SIGNATURE


DATE	REVISION

PROJECT

156 EAST 71 STREET



R8B	BLOCK	1405
8C	LOT	47
Ē	DATE	07/31/24
	JOB NO.:	0147
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2)54	DRAWING NO .:	
	L-30	2.00
	8C	8C LOT DATE JOB NO.: SCALE: DRAWING NO.:

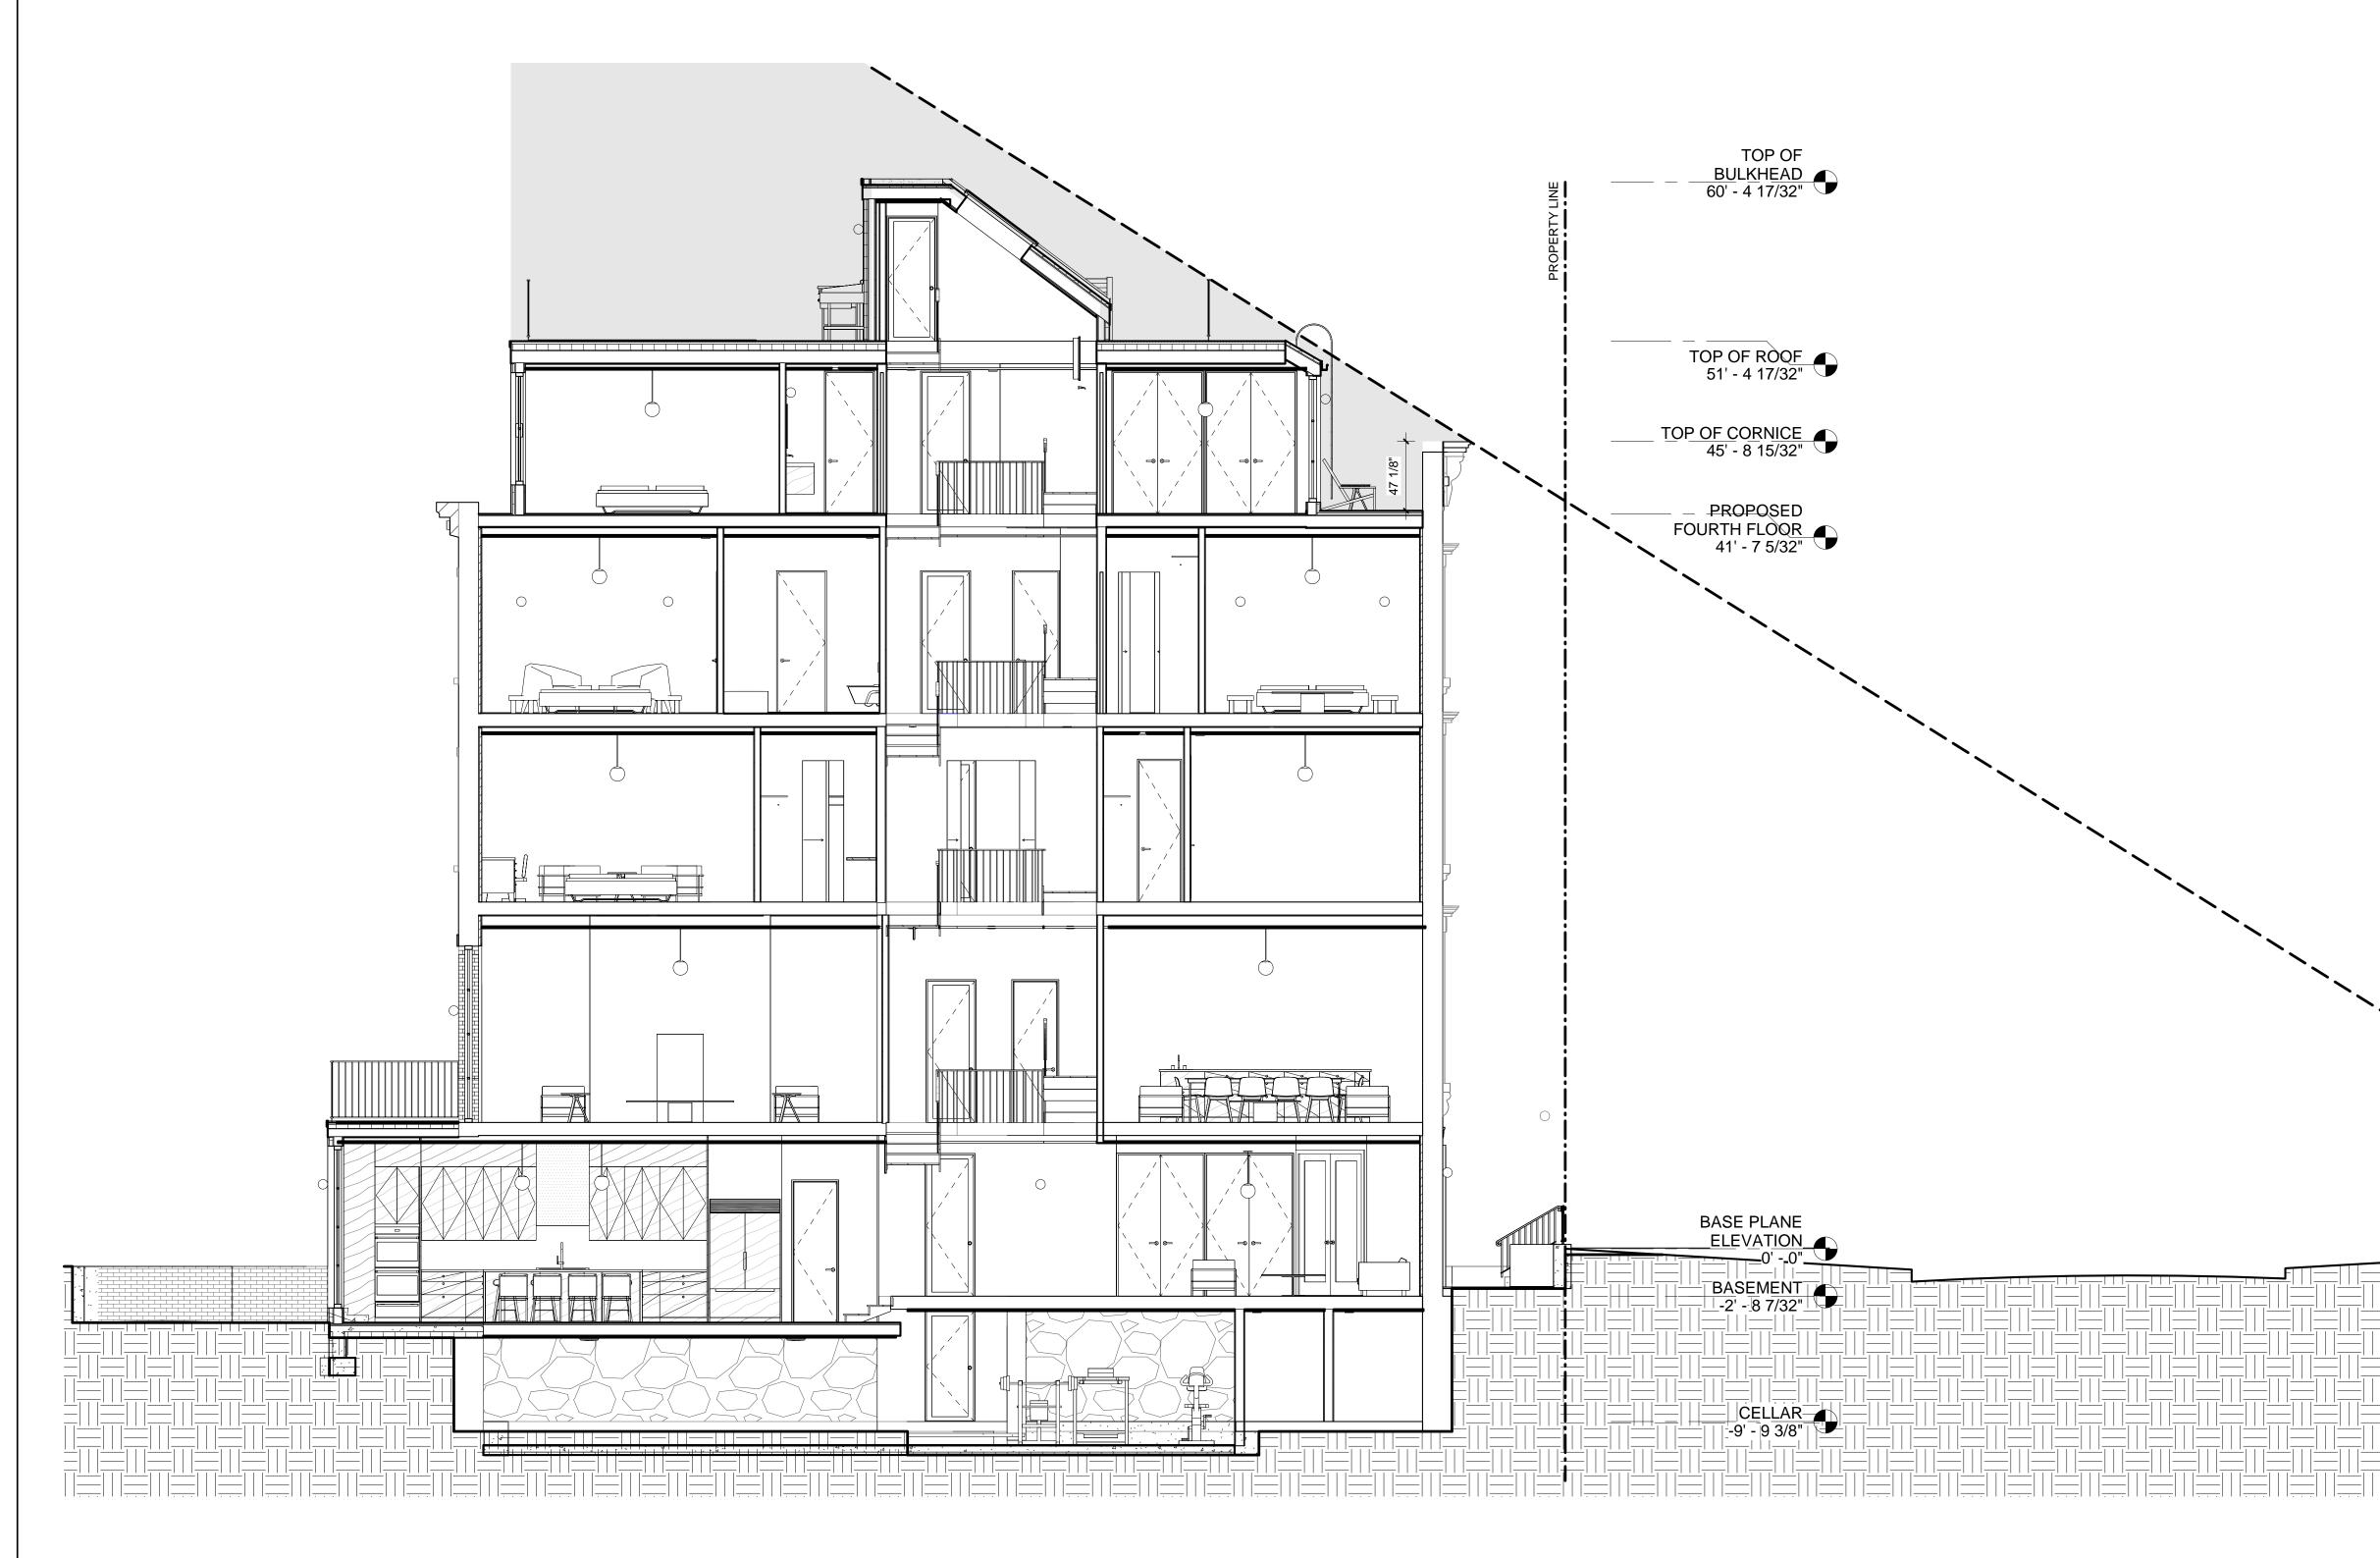

156 E 71 ST
156 EAST 71 STREET
Architect
Daniel Kaplan, RA Bowerbird Architects, PLLC 124 9th St. Suite 250 Brooklyn NY 11215 Tel: 917.447.7855
Owner Steel Property Group
Code Consultant Reuven Kalish reuven@professionalzoning.com
Structural Engineer
Aleksandr Yaker, PE Yaker Engineering, PC 1679 E 19th St., Ste 2A Brooklyn, NY 11229 Cell: (917) 518-2032 Fax: (718) 376-1283
MEP Engineer
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LANDMARKS SUBMISSION 01/06/2025
DOB APPLICATION NO.: B01026912-I1
DOB EXAMINER - SEAL & SIGNATURE
DATE REVISION
PROJECT 156 EAST 71 STREET
TITLE ROOF VISIBILITY DIAGRAM
ZONING DISTRICTR8BBLOCK1405ZONING MAP8CLOT47SEAL & SIGNATUREDATE07/31/24JOB NO.:0147SCALE:AS NOTED


EOFN © BOWERBIRD ARCHITECTS 2024 - DO NOT SCALE FROM DRAWINGS

DRAWING NO .:

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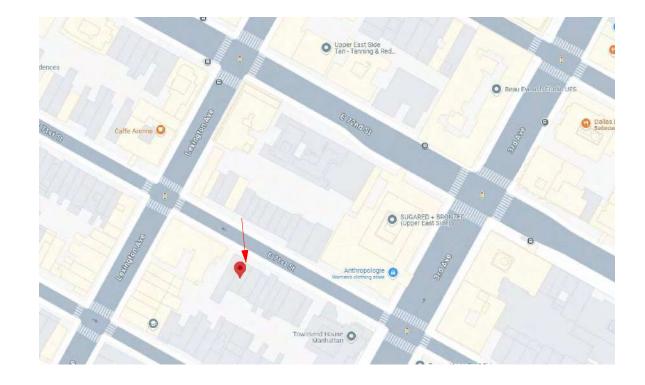
PHOTOS SHOWING PROPS THATE WERE PREPARED TO STUDY ROOFTOP ADDITION VISIBILITY



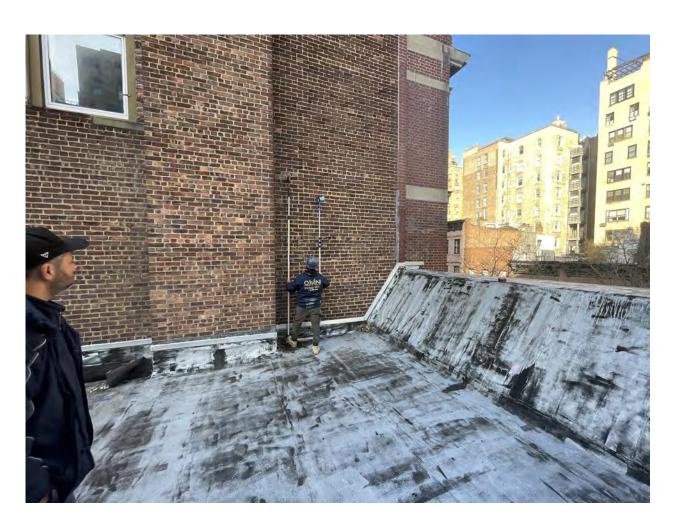


LOOKING WEST

LOOKING EAST






VIEW FROM SOUTHEAST FROM THE OPPOSITE SIDEWALK - NO ROOFTOP EXTENSION VISIBILITY

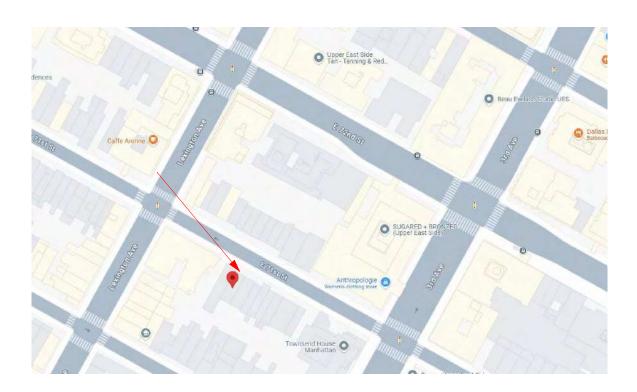




VIEW FROM LEXINGTON AVENUE - NO ROOFTOP EXTENSION VISIBILITY



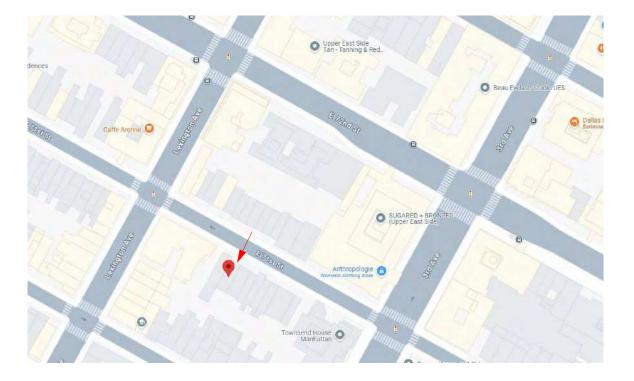

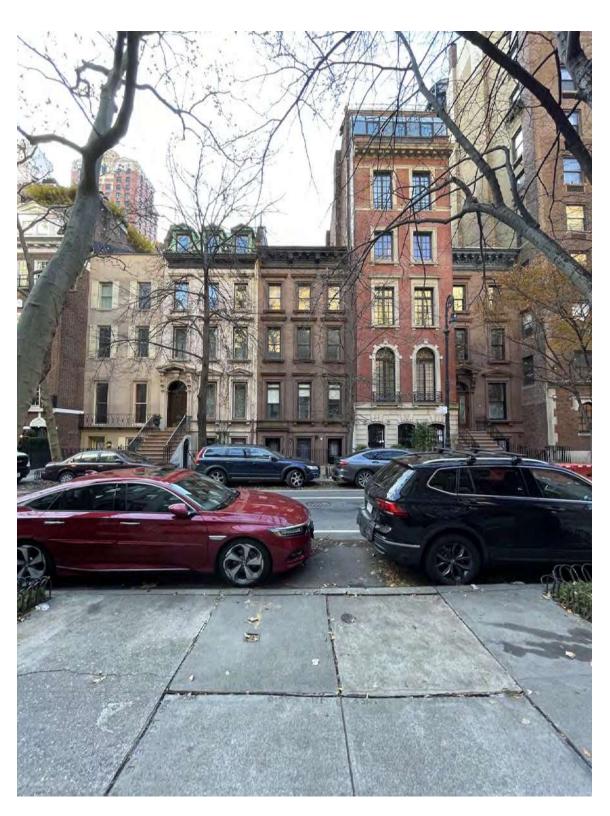

VIEW ACROSS FROM THE OPPOSITE SIDEWALK - NO ROOFTOP EXTENSION VISIBILITY

156 E 71 ST

156 EAST 71 STREET

Architect

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Owner

Steel Property Group

Code Consultant

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LANDMARKS SUBMISSION 01/06/2025

DOB APPLICATION NO.: B01026912-I1

DOB EXAMINER - SEAL & SIGNATURE


DATE	REVISION

PROJECT

156 EAST 71 STREET


TITLE ROOF VISIBILITY ANALYSIS -SORROUNDINGS

ZONING DISTRICT	R8B	BLOCK	1405	
ZONING MAP	8C	LOT	47	
SEAL & SIGNATURE		DATE	07/31/24	
DARC		JOB NO.:	0147	
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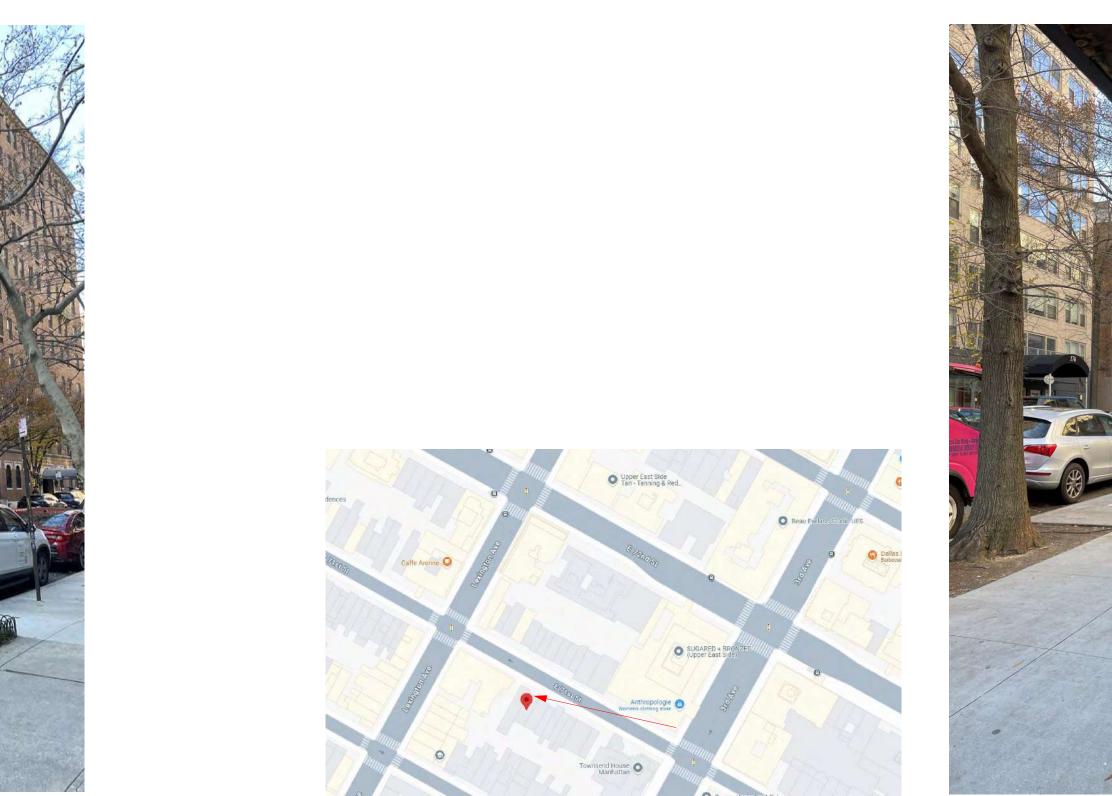


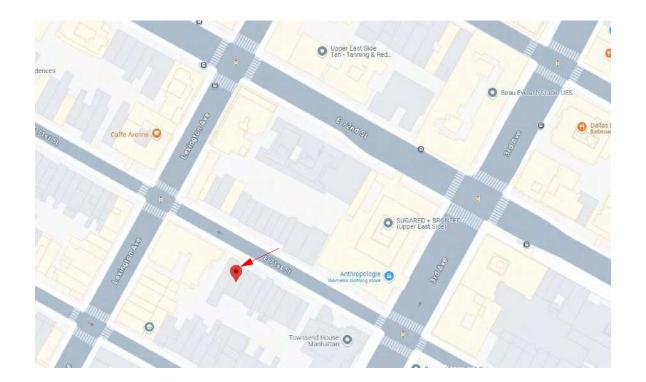VIEW FROM NORTHEAST - NO ROOFTOP EXTENSION VISIBILITY



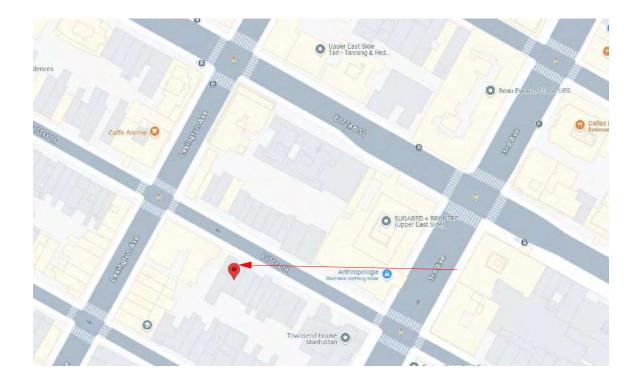

VIEW FROM ACROSS 3RD AVENUE FROM THE OPPOSITE SIDEWALK - ROOFTOP EXTENSION MIGHT BE VISIBLE BUT COULDN'T BE ASSESSED WITH NAKED EYE





HIGHLY ZOOMED IN PHOTO WITH OUTLINE OF POTENTIALLY VISIBLE ROOF EXTENSION OBSCURED BY TREE BRANCHES



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DOB EXAMINER - SEAL & SIGNATURE

REVISION

PROJECT

156 EAST 71 STREET

TITLE ROOF VISIBILITY ANALYSIS -FROM LEXINGTON AVENUE

ZONING DISTRICT	R8B	BLOCK	1405
ZONING MAP 8C SEAL & SIGNATURE		LOT DATE	47 07/31/24
SEAL & SIGNATURE	The A	JOB NO.: SCALE: DRAWING NO.:	0147 AS NOTED
HE OF NEW		L-305.00	
		NOT SCALE FROM DRA	WINGS

CHEMICALLY REMOVING PAINT FROM BRICK MASONRY

PART 1---GENERAL

1.01 SUMMARY

Α.	This procedure includes guidance on chemically removing paint from and repainting brick masonry.	3.01 EXAMINA	TION		
	NOTE: Sandblasting is not recommended by the secretary of the interior's standards for rehabilitation and shall not be used. High- pressure water blasting is also not recommended without adequate testing or experience as it may erode soft brick and drive	A. B.	Befor	RMINE T e work is	begun o
D	moisture into the wall. Briek, preparty fixed is a durable surface which does not need a specificial costing such as point, to protect it. Pointing often creates		snall	be inspec	ted and
В.	Brick, properly fired, is a durable surface which does not need a sacrificial coating such as paint, to protect it. Painting often creates long term maintenance problems. However, brick that has been painted, is usually NOT properly fired and needs the protection				
	provided by the application of paint. Furthermore, brick which has been damaged by abrasive cleaning may require painting in order	3.02 PREPAR			
	to seal the masonry from excessive water penetration which, if not protected, can lead to further deterioration of the masonry.	3.02 FREFAR		ce Prepar	ration: D
C.	Safety Precautions:	А.	Suna	se Frepai	
С.					
	CAUTION: chemicals often used to remove paint are highly caustic to flesh and toxic.				
	1. Both acids and alkalies are used in the cleaning process. The wrong type of acid can burn and/or dissolve both the brick and	3.03 ERECTIO			
	the mortar. Adjacent and imbedded materials, i.e. glass or iron cramps, can also be damaged.	Α.		Removal	
	2. Failure to properly neutralize the chemicals, or inadequate rinsing can cause salts, stains and other residues to remain on the		1.		ally scrap
D	surface of the brick, residues which may be impossible to remove.		~		are quite
D.	Historic Structure Precautions:		2.		an off-th
	1. Masonry buildings were sometimes painted from the start. A study of all of the paint layers should be conducted to determine			a.	Thicke
	what were the original colors and if any special treatments were used.			b.	Apply
	2. For buildings in which all paint is to be removed, retain small representative areas of paint to provide a paint history of the			C.	Cover
	building for future research.				film.
	3. An archives of the paint history of the building is to be maintained. This is to include any paint samples taken during research,			d.	When
_	samples of the new paint colors and the manufacturer's technical information.				the lov
E.	See 01100-07-S for general project guidelines to be reviewed along with this procedure. These guidelines cover the following				800 ps
	sections:				Supple
	1. Safety Precautions				-OR-
	2. Historic Structures Precautions		3.	Apply	a proprie
	3. Submittals			a.	Apply
	4. Quality Assurance				Press
	5. Delivery, Storage and Handling				brick a
	6. Project/Site Conditions				done j
	7. Sequencing and Scheduling			b.	Allow
	8. General Protection (Surface and Surrounding)			C.	Rinse
	These guidelines should be reviewed prior to performing this procedure and should be followed, when applicable, along with				Mainta
	recommendations from the Regional Historic Preservation Officer (RHPO).			d.	Apply
F.	For general information on the characteristics, uses and problems associated with paint, see 09900-04-S. See also 09900-07-S for				instruc
	other guidelines pertaining to paint removal and application.			e.	Rinse
			4.	After p	aint has
				neutra	lizer. A r
1.02 SUBMITTA	LS		5.	Allow ı	neutraliz
А.	Samples:		6.	Thorou	ughly rin:
	1. Under the supervision of the RHPO, test panels, using the appropriate cleaning methods, shall be done to determine the best		7.		ne pH wi
	method to remove paint. The "best method" shall be defined as that which successfully removes the paint with no, or			a.	Dissol
	minimal, damage to the masonry substrate.			b.	Brush
	2. Testing shall be done in unobtrusive locations on each building exposure. The methods used, their application, etc. shall be		8.	Contin	ue to ne
	in accordance with manufacturer's instructions and shall duplicate those procedures proposed for the overall paint stripping				ers neutr
	process. The RHPO shall select the test areas and shall conduct a thorough evaluation of each method after paint removal is			- 0	
	complete to determine the best method for the overall stripping.				
	3. The testing shall include an evaluation of the materials and techniques proposed for the protection of surrounding areas from				
	the chemicals used to strip the paint. Especially important is an evaluation of the method to be used to collect the cleaning				
	effluent.				
	4. A representative of the cleaning materials manufacturer(s) (for proprietary cleaning systems) shall be present during the				
	preparation and application of the test areas.				

1.03 PROJECT SITE CONDITIONS A. Environmental Requi

Environmental Requirements:
 To prevent water in the masonry from freezing, no paint stripping shall be done if temperatures are expected to fall below 40-48 degrees (F) during the stripping process, or within 24 hours of completing the stripping. If allowed by the chemical

manufacturer, heated rinse water may be used if lower temperatures are expected.No cleaning shall be conducted during periods of strong winds when the chemicals may be spread to adjacent unprotected

- Surfaces.
 Unless otherwise recommended by the paint manufacturer, the ambient temperature shall be between 50-58 degrees (F.)
- and 95-98 degrees (F.) Do not apply paints when the temperature is expected to fall below 50-58 degrees (F) during the first 24 hours after application.

4. Do not apply any of the coats of paint in the direct sun. It shall be applied only when the surface to be painted is in the shade and the sun is shining on the opposite elevation. The west elevation should be painted in the morning when the sun is shining on the east elevation; the north elevation should be paint around noon when the sun is shining on the south elevation; the east elevation should be painted in the afternoon when the sun is shining on the west elevation; and the south elevation should be painted late in the afternoon when it is in full shade.

5. Do not apply paint to damp surfaces, in misty or rainy weather, in the snow or where there is visible ice or frost on the surfaces.

PART 2---PRODUCTS

2 01 MANUFACTURERS

2.01 MANUF	ACTURERS	
Α.	Proprietary C	hemicals: (one of the following, or approved equal)
	1. ProS	oCo, Inc. [a nongovernment website], Lawrence, KS 66117, 800-255-4255
	2. Died	rich Technologies Inc. [a nongovernment website], Schenectady, NY 12303, 800-283-3888
	3. Hydi	ochemical Techniques, Inc. P.O. Box 2078, Hartford, CT, 06145. 800-278-7681, info@hydroclean.com
	4. Dum	ond Chemicals, Inc [a nongovernment website] West Chester, PA (corporate office), 800-245-1191 or 609-655-7700,
	info	2 dumondglobal.com
2.02 MATERI	ALS	
А.	Off-the-Shelf	Chemical Paint Removers:
	1. Sem	i-paste, water rinsing, non-benzol removers such as Strypeeze Semi-paste, or approved equal.
	a.	Characteristic orange color.
	b.	Will work on both latex and oil-based paints, lacquers and varnishes.
	С.	Cling well to round or vertical surfaces. Form an anti-evaporative film as they dry.
		flammable, heavy bodied, methylene-chloride based removers such as Superstrip Nonflammable, Zip Strip, or approved
	equa	
	a.	Good for interior use because they are non-flammable.
	b.	Will soften oil-based paints, lacquers, varnish and synthetic baked finishes.
	С.	Because they are so heavy bodied they will cling to vertical and irregular surfaces.
		starch or fumed silica to further thicken chemicals so they will adhere to vertical surfaces.
	-OR	
	One	of the following proprietary paint strippers, or approved equal:
	a.	Sure Klean Heavy Duty Paint Stripper (ProSoCo, Inc.)
	b.	Sure Klean 859 Stripper (ProSoCo, Inc.)
	С.	Blok-Guard & Graffiti Control II (ProSoCo, Inc.)
	d.	Envirestrip Paint Remover (Diedrich Technologies)
	e.	505 Special Coatings Stripper (Diedrich Technologies)
	f.	606, 606X Caustic Multi-layer Paint Remover (Diedrich Technologies)
	g.	Heavy Duty Paint Remover (Hydroclean)
_	h.	Peel Away 1,2 (Dumond Chemicals, Inc.)
B.		e water to remove chemical residue.
С.		ein: Used to test pH of a surface after stripping with chemicals or any alkaline product. Available at some drug stores or
_	chemical sup	
D.		white vinegar or other appropriate neutralizer such as Sure Klean Restoration Cleaner (ProSoCo, Inc.), 101 Masonry
_		aner (Diedrich Technologies), or approved equal.
E.		he same manufacturer and appropriately suited for the conditions.
		O NOT USE A VAPOR-IMPERMEABLE PAINT ON SURFACES THAT MIGHT HOLD DAMP FROM GROUND OR
	THROUGH V	VALLS SUCH AS BADLY-PITTED BRICK CAUSED BY SANDBLASTING.

3.03 EQUIPMENT

- A. Paint scrapers
- B. Putty knives
- C. Stiff bristle brushes to remove loose, flaky paintD. Natural fiber cleaning brush
- E. Synthetic fiber brush
- F. Rollers, and/or spray equipment as appropriate and a recommended by paint stripper manufacturers for the application of their
- various products. Not all types of brushes, etc. are appropriate for all chemicals.
- G. Plastic sheeting and duct tape may be necessary to coverthe stripper during dwell time as it evaporates quickly.
- H. Scrapers and/or pressure rinsing equipment to remove sludge.
- Nylon bristle brusheS Garden hose

EASON FOR PAINT REMOVAL AND WHY THE BUILDING WAS ORIGINALLY PAINTED. on removing the existing paint film or otherwise preparing the surface, all flashing, gutters and downspouts d repaired or replaced as required.

Repoint any open mortar joints to prevent water and chemicals from entering the wall structure.

PLICATION

PART 3---EXECUTION

rape all loose paint and efflorescence using paint scrapers, putty knives or stiff bristle brushes. If the mortar and uite crumbly, use a softer brush.

the shelf methylene chloride-based paint remover (for small surface areas): ken stripper with cornstarch as necessary.

ly stripper to the surface by brush.

er with plastic wrap or keep misted to prevent chemical from drying out before it has had time to soften paint

en paint film is softened, rinse surface completely using a garden hose or pressure washing equipment. Use lowest pressure which will remove paint and paint remover - usually about 300 to 500 psi, but no higher than psi and only on approval of RHPO. HIGH PRESSURE WATER BLASTING IS NOT RECOMMENDED. plement rinsing as necessary with a wood or plastic scrapper. Repeat if required to remove all paint.

rietary chemical paint remover (for large surface areas):

ly chemical paint remover with a brush, roller or appropriate spray equipment as directed by manufacturer. ssure application of paint stripping materials shall not be done as it tends to drive the chemicals too far into the k and mortar making it impossible to remove all residue. Final dilution ratio to be determined by test patches e prior to removal process.

w the stripper to stay on the brick as directed by the manufacturer and as determined by test patches. Se completely with clean, fresh water using pressure washing equipment to remove all paint and residue. Intain water pressures as recommended by chemical manufacturer and RHPO. If a second coat of paint stripper if necessary to remove remaining paint, again following manufacturer's

ructions. se completely again and apply afterwash as recommended by chemical manufacturer.

as been removed, but before brick dries, apply neutralizer such as white vinegar, or a proprietary chemical a neutral Ph (7 pH) should be achieved before repainting.

lizer to stand on wall about three minutes before rinsing. DO NOT LET IT DRY!

inse the surface with clean, clear water.

with litmus paper or phenolphthalein:

solve a 2" piece of phenolphthalein in denatured alcohol.

sh the solution onto the surface. If it turns a shade from pink to magenta there is still chemical residue. neutralize the surface and test until there is no color change in the phenolphthalein solution or the litmus paper utral.

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PROJECT

156 EAST 71 STREET

TITLE

APPENDIX

	DOD		1405
ZONING DISTRICT	R8B 8C	BLOCK LOT	1405 47
		DATE	07/31/24
SEAL & SIGNATURE		JOB NO.:	0147
EREDINC	TEN	SCALE:	AS NOTED
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