

JAMES B. DUKE HOUSE

THE INSTITUTE OF FINE ARTS

1 EAST 78TH STREET



- PROVIDE ADA ACCESS TO THE BASEMENT FLOOR
- NO CHANGE TO EXTERIOR FACADE



1 East 78th Street

1 East 78th Str

New York, NY 10075

Matiz Architecture & Design 244 5th Ave, 5th Floor New York, NY 10001 T. 212 982 4613 www.MAD-NYC.com

structural engineer

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9 8 7 6 5 4 1 2.09.24 2 100% DD/LPC SUBMISSION 10.28.24 1 50% DESIGN DEVELOPMENT 12.22.23

project number 2201A date

12.09.24

scale
AS NOTED

SITE PLAN & HISTORIC PHOTO

LPC-01




HISTORICAL TAX PHOTO 1980

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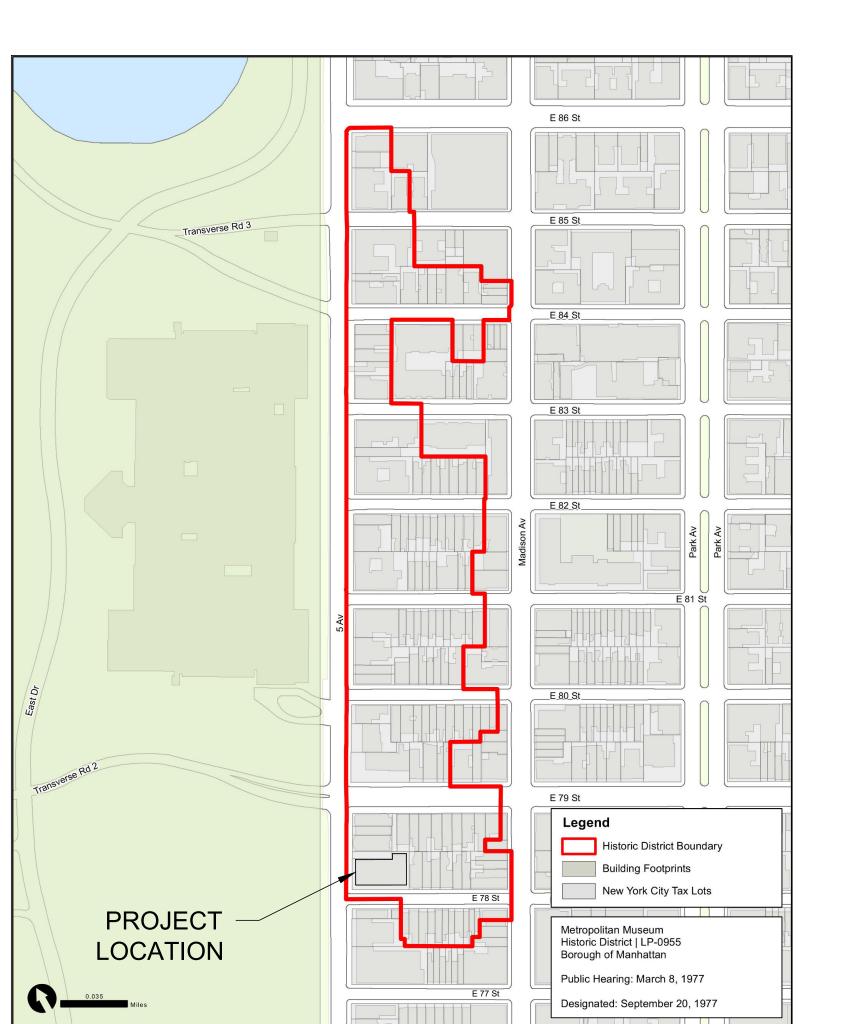


PHOTO OF CURRENT CONDITIONS 2023

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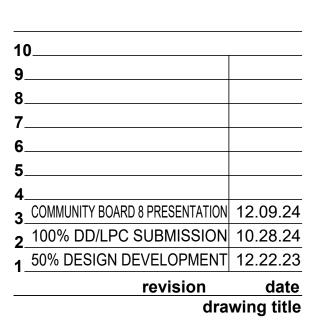


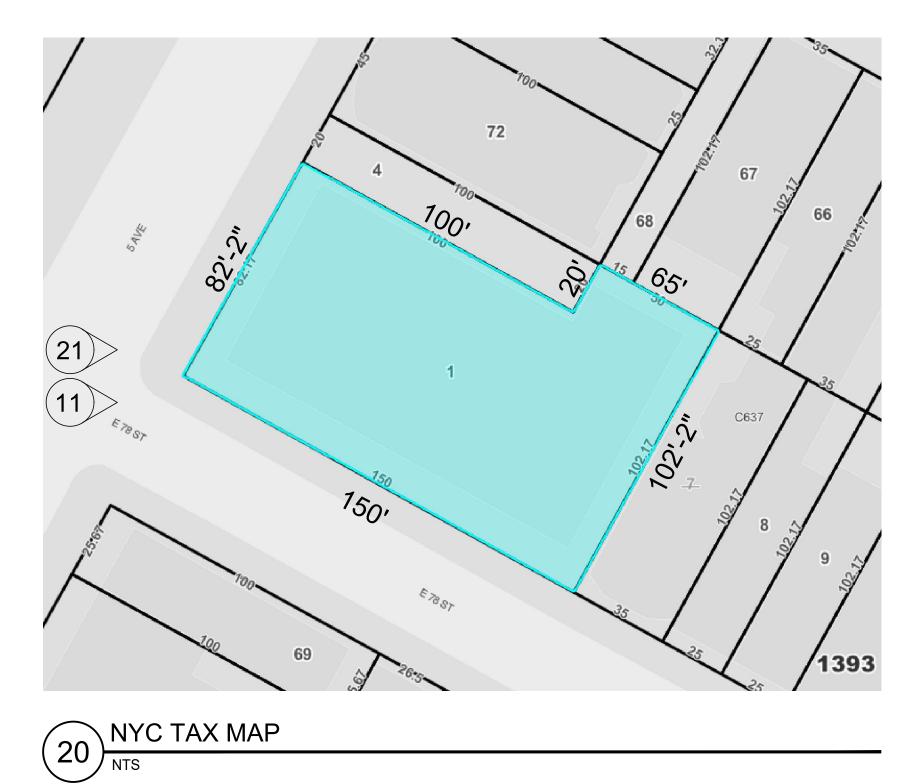

ADDRESS: 1 EAST 78TH STREET TAX BLOCK: 1393 TAX LOT: 1 **ZONE:** R10 & R8B MAP: 8C

METROPOLITAN MUSEUM HISTORIC DISTRICT (RED OUTLINE)

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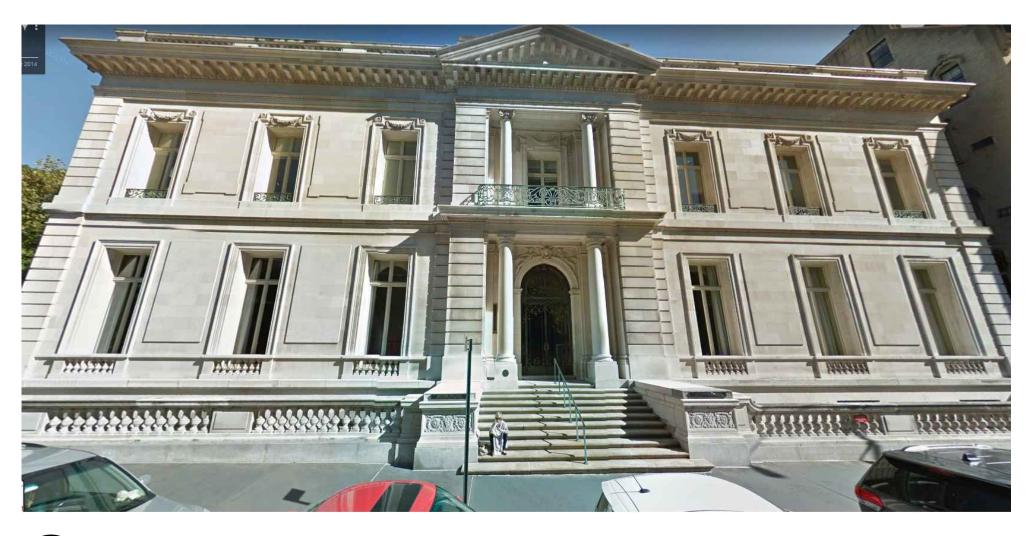
architect

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project number 2201A 12.09.24 scale AS NOTED

SITE PLAN & HISTORIC PHOTO










(31) EXISTING NORTHERN VIEW FROM BUILDING CORNER




EXISTING NORTHERN VIEW FROM FRONT OF 3 E. 78TH ST.

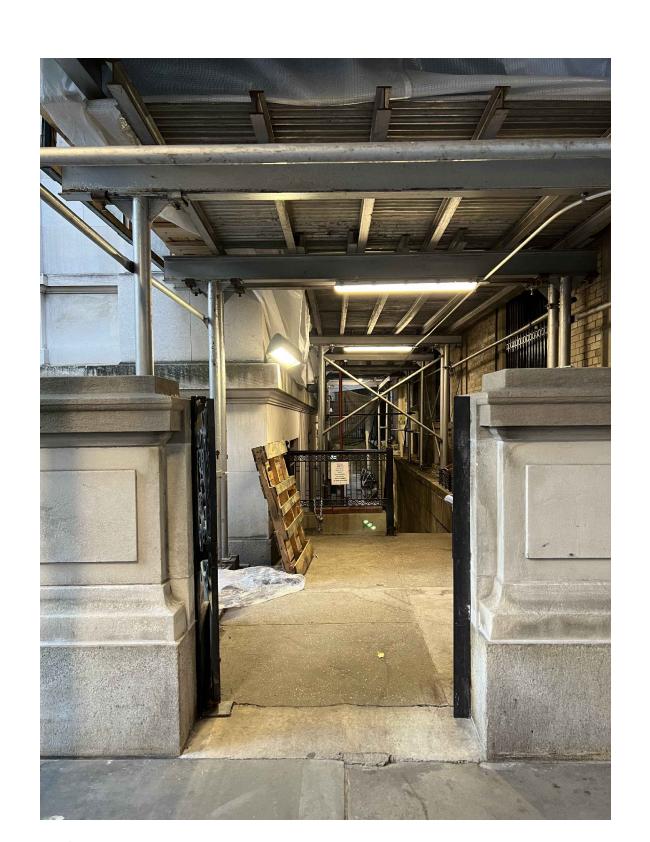

20 EXISTING EAST 78TH STREET VIEW FROM SIDEWALK

PROJECT SCOPE:

- A. PROVIDE ADA ACCESS TO THE BASEMENT FLOOR
- B. INSTALL ADA LIFT ON EAST SIDE OF BUILDING WITHIN AREAWAY
- C. MAJORITY OF PROPOSED IMPROVEMENTS ARE HIDDEN FROM STREET LINE OF SIGHT
- D. NO CHANGE TO EXTERIOR FACADE
- E. REBUILDING OF EXTERIOR ACCESS STAIRWAY DUE TO DETERIORATING STRUCTURAL STEEL. (RELATED AND SEPARATE PROJECT BY NYU WITH OTHER PROFESSIONAL)

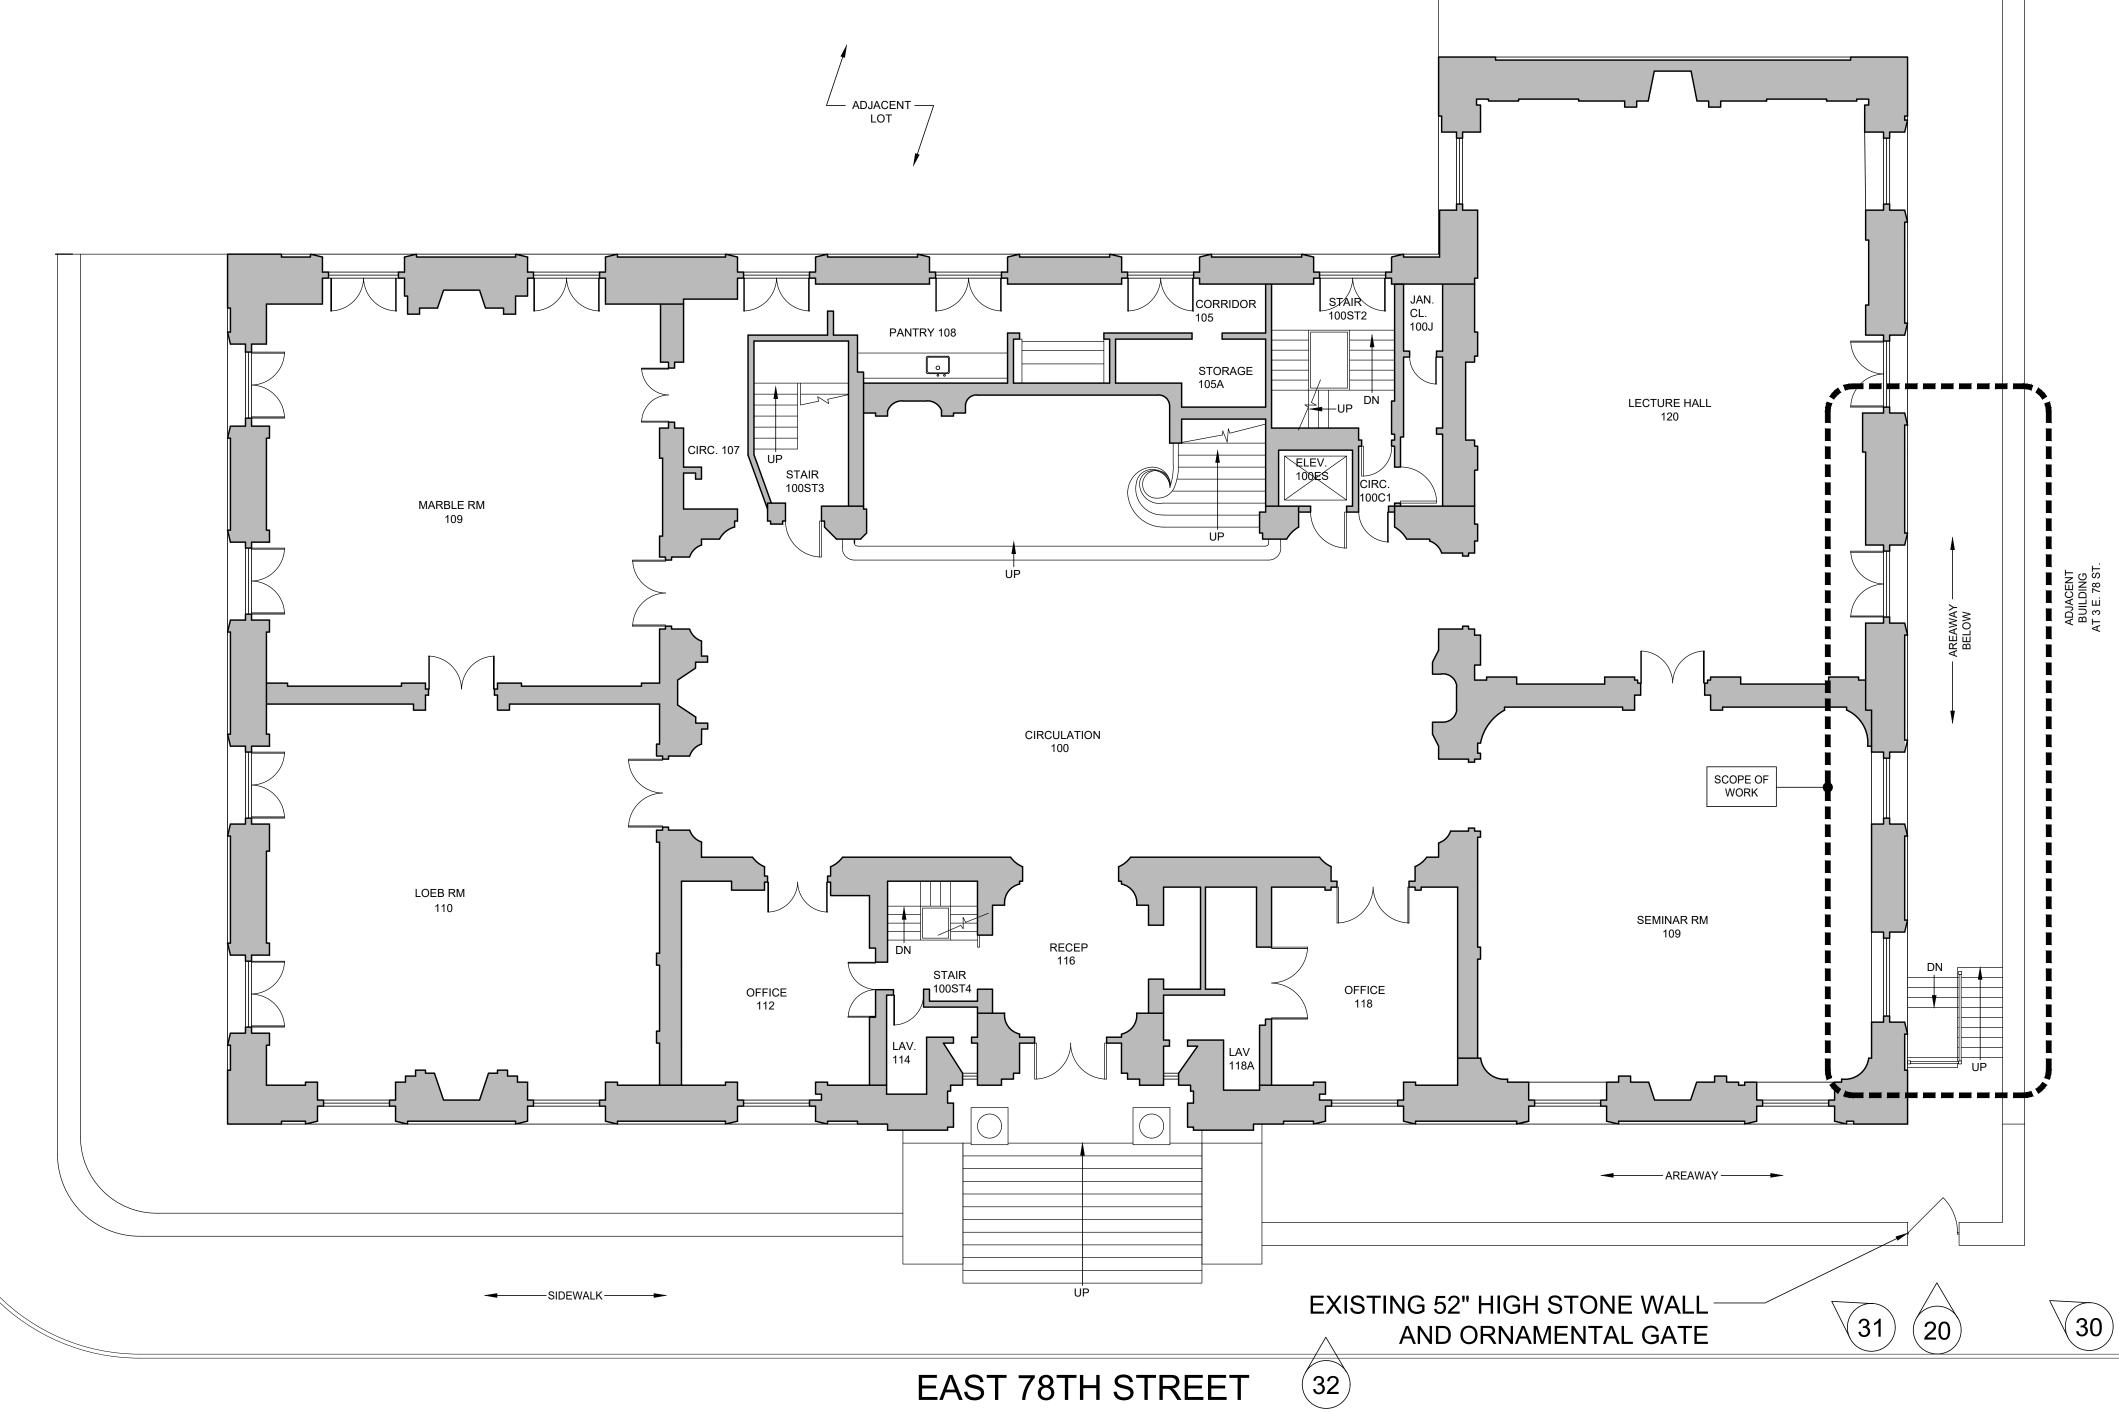

EXISTING FIRST FLOOR PLAN

SCALE: 1/8" = 1' - 0"

LPC-03

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50% DESIGN DEVELOPMENT 12.22.23

n date drawing title

project number

2201A

12.09.24

scale AS NOTED

FIRST FLOOR

REFERENCE PLAN

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architect


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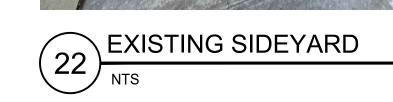
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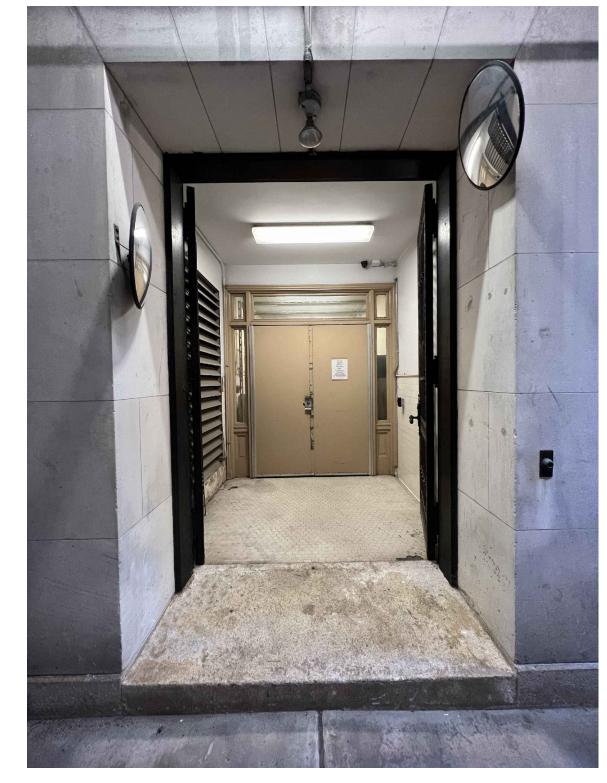
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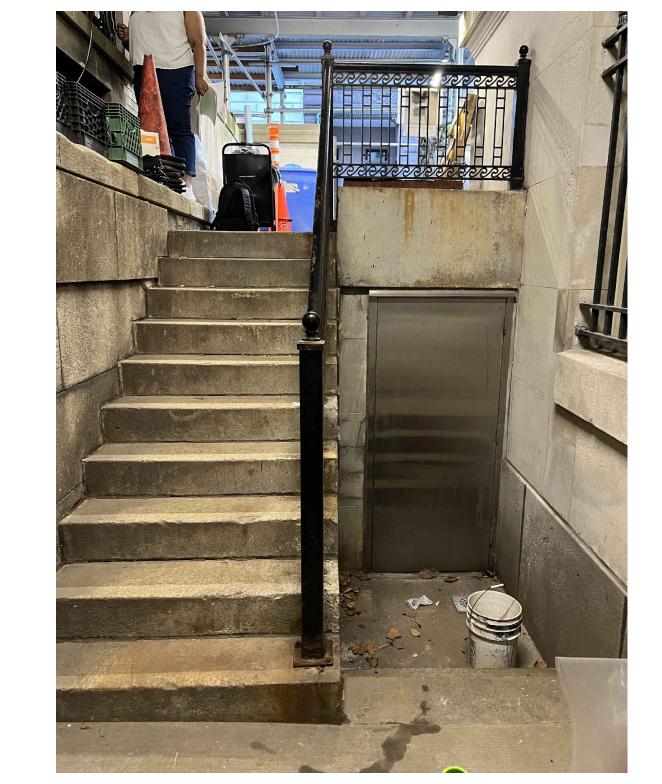




EXISTING DOORWAY AT BASEMENT

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FIFTH AVENUE

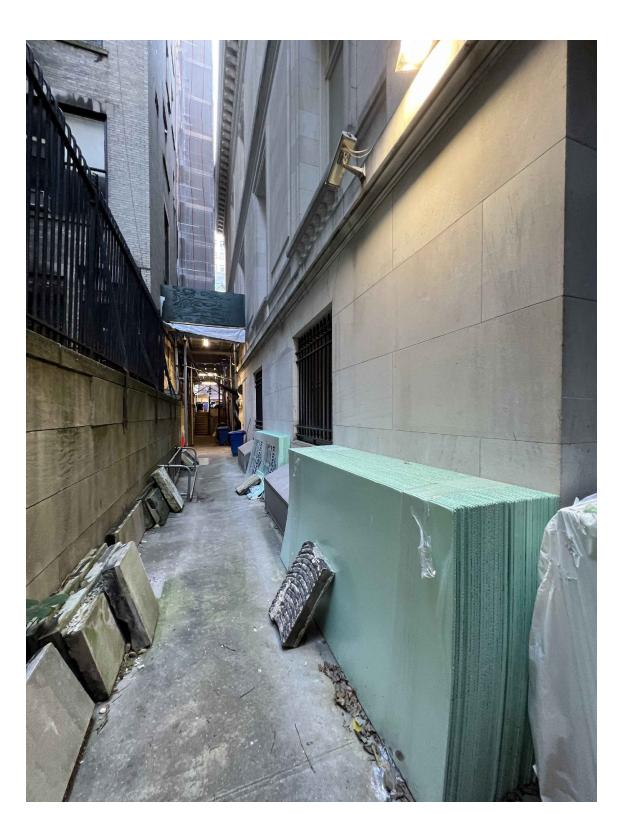

EXISTING STAIR

NTS



EAST 78TH STREET

EXISTING BASEMENT PLAN

(10) SCALE: 1/8" = 1' - 0"

EXISTING STAIR

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CONDITION NOTES:

A. REBUILDING OF EXTERIOR ACCESS STAIR DUE TO DETERIORATING STRUCTURAL STEEL APPROVED UNDER SEPERATE LPC APPLICATION: LPC-19-33441



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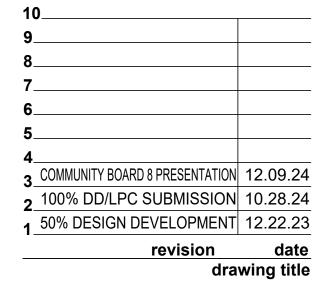
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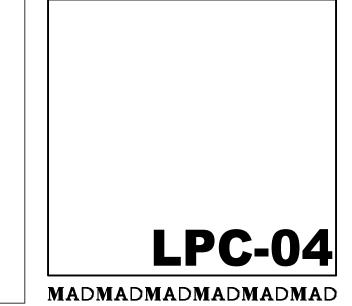
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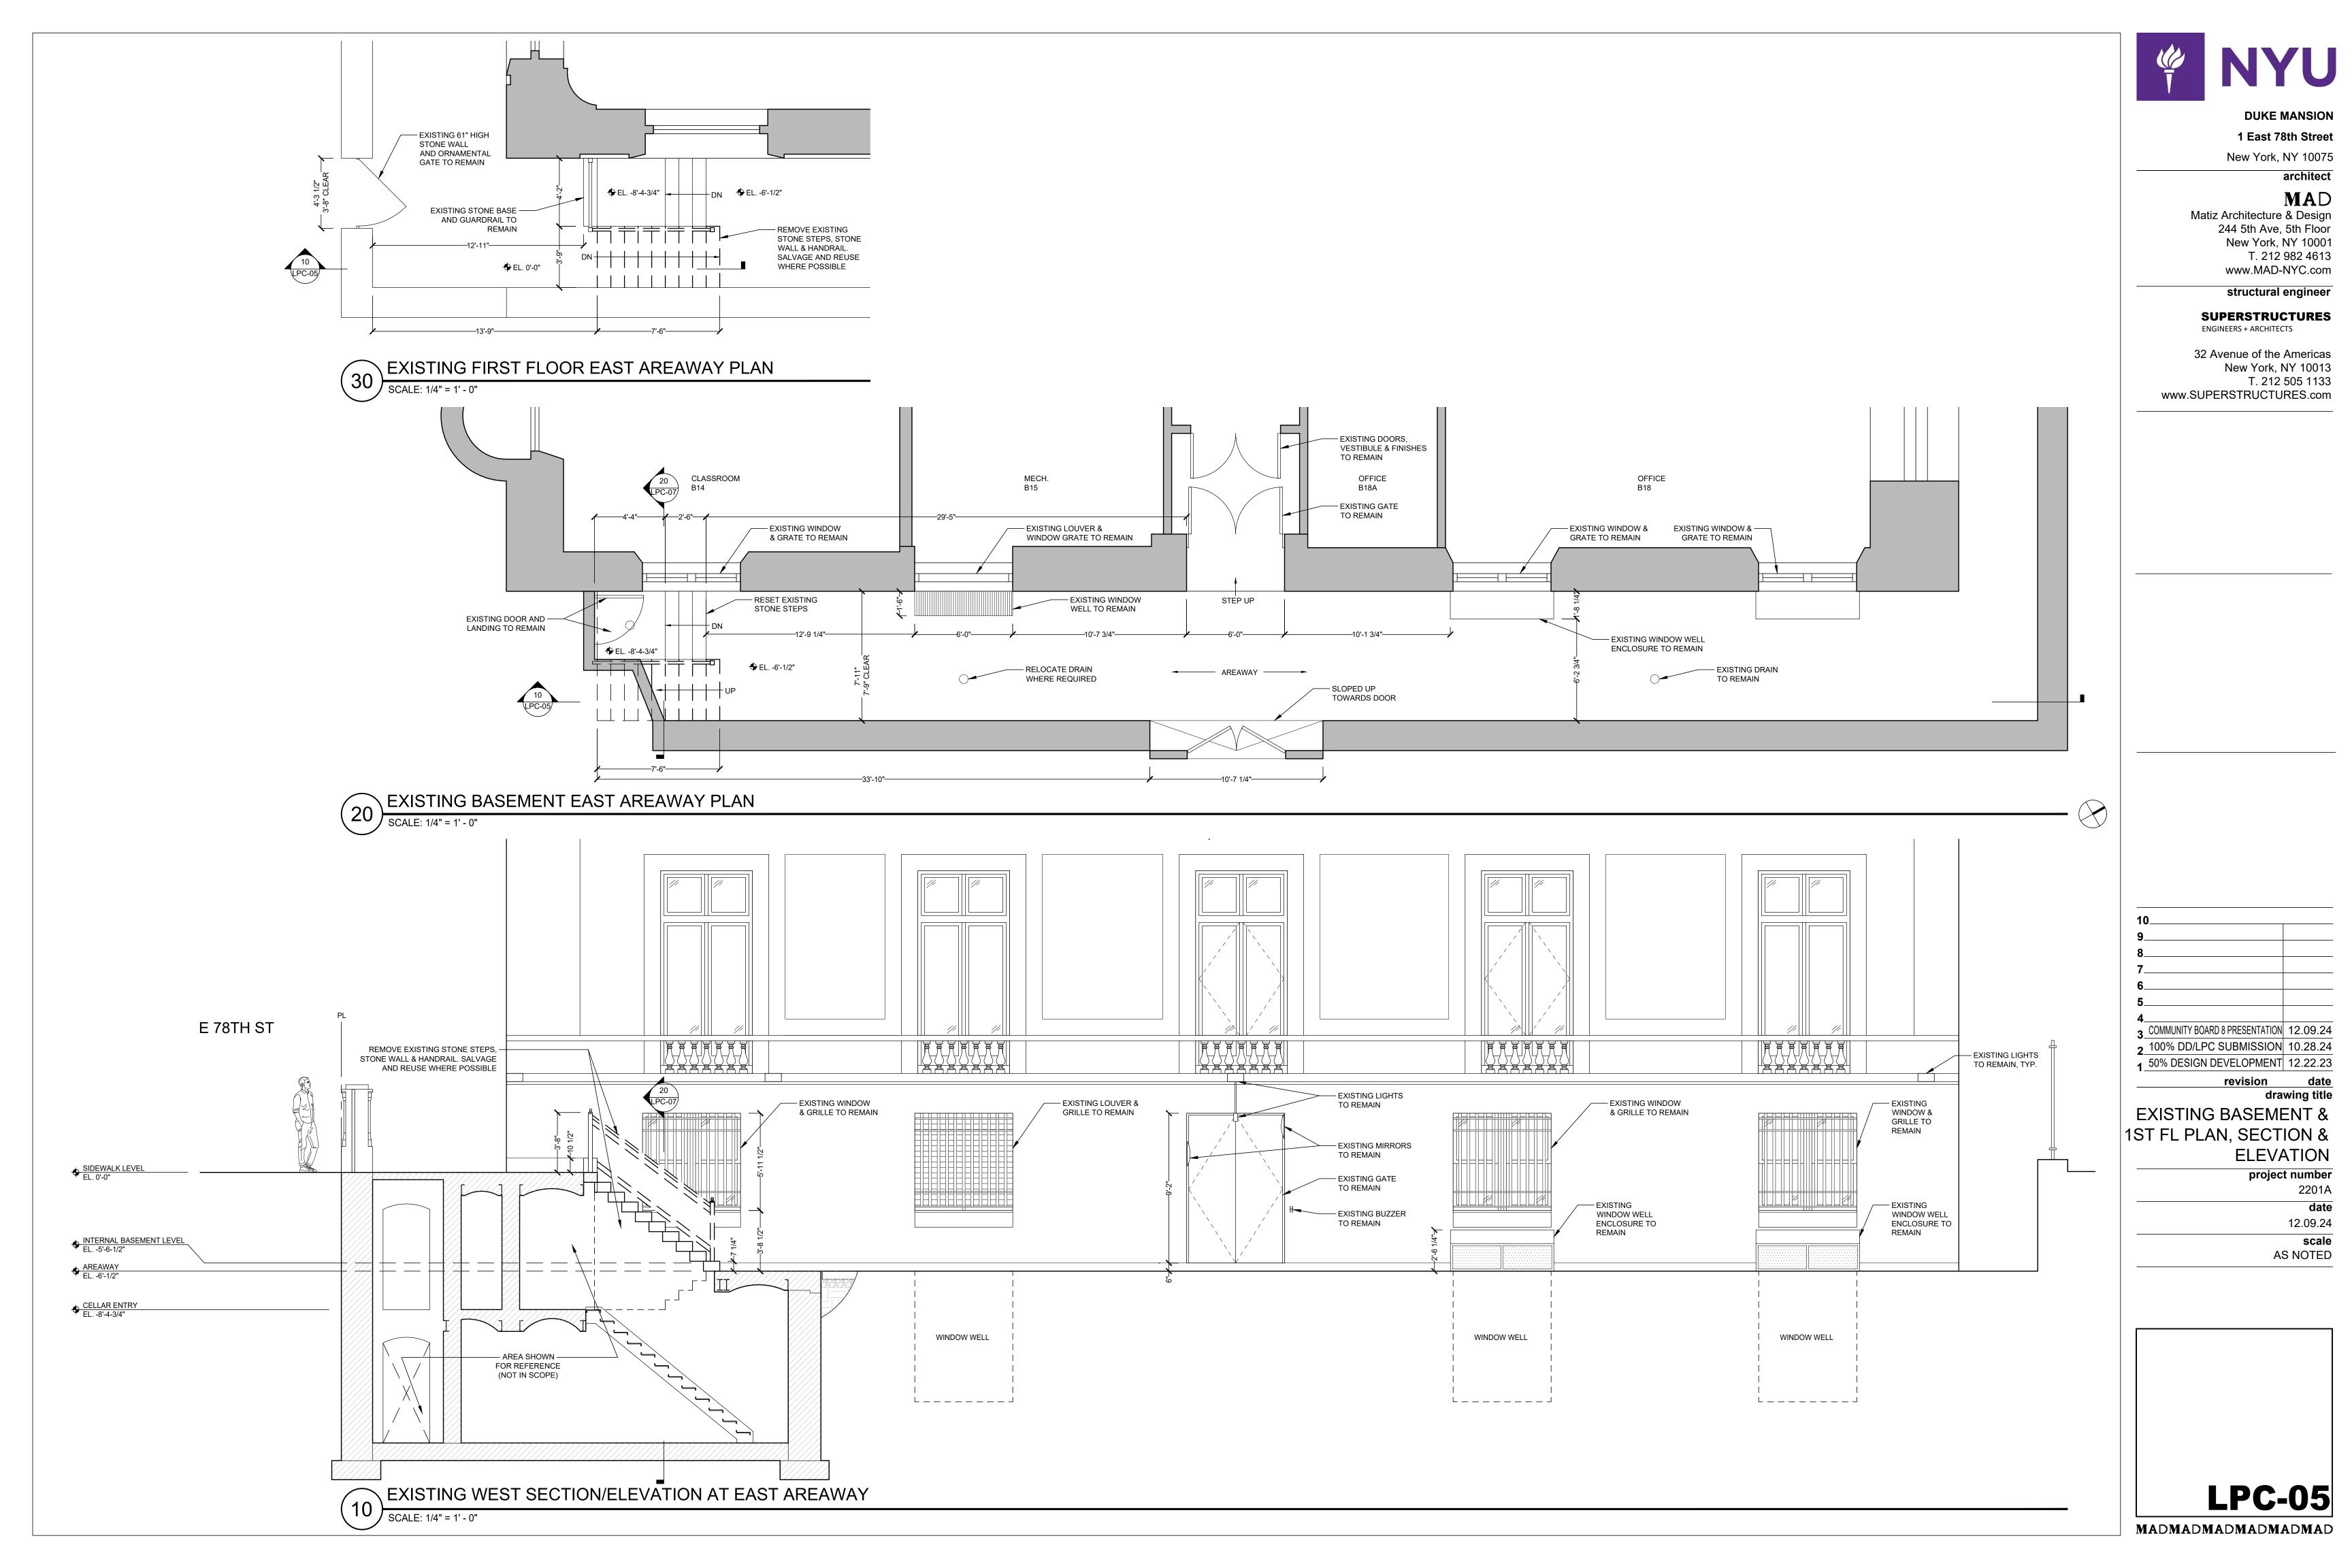
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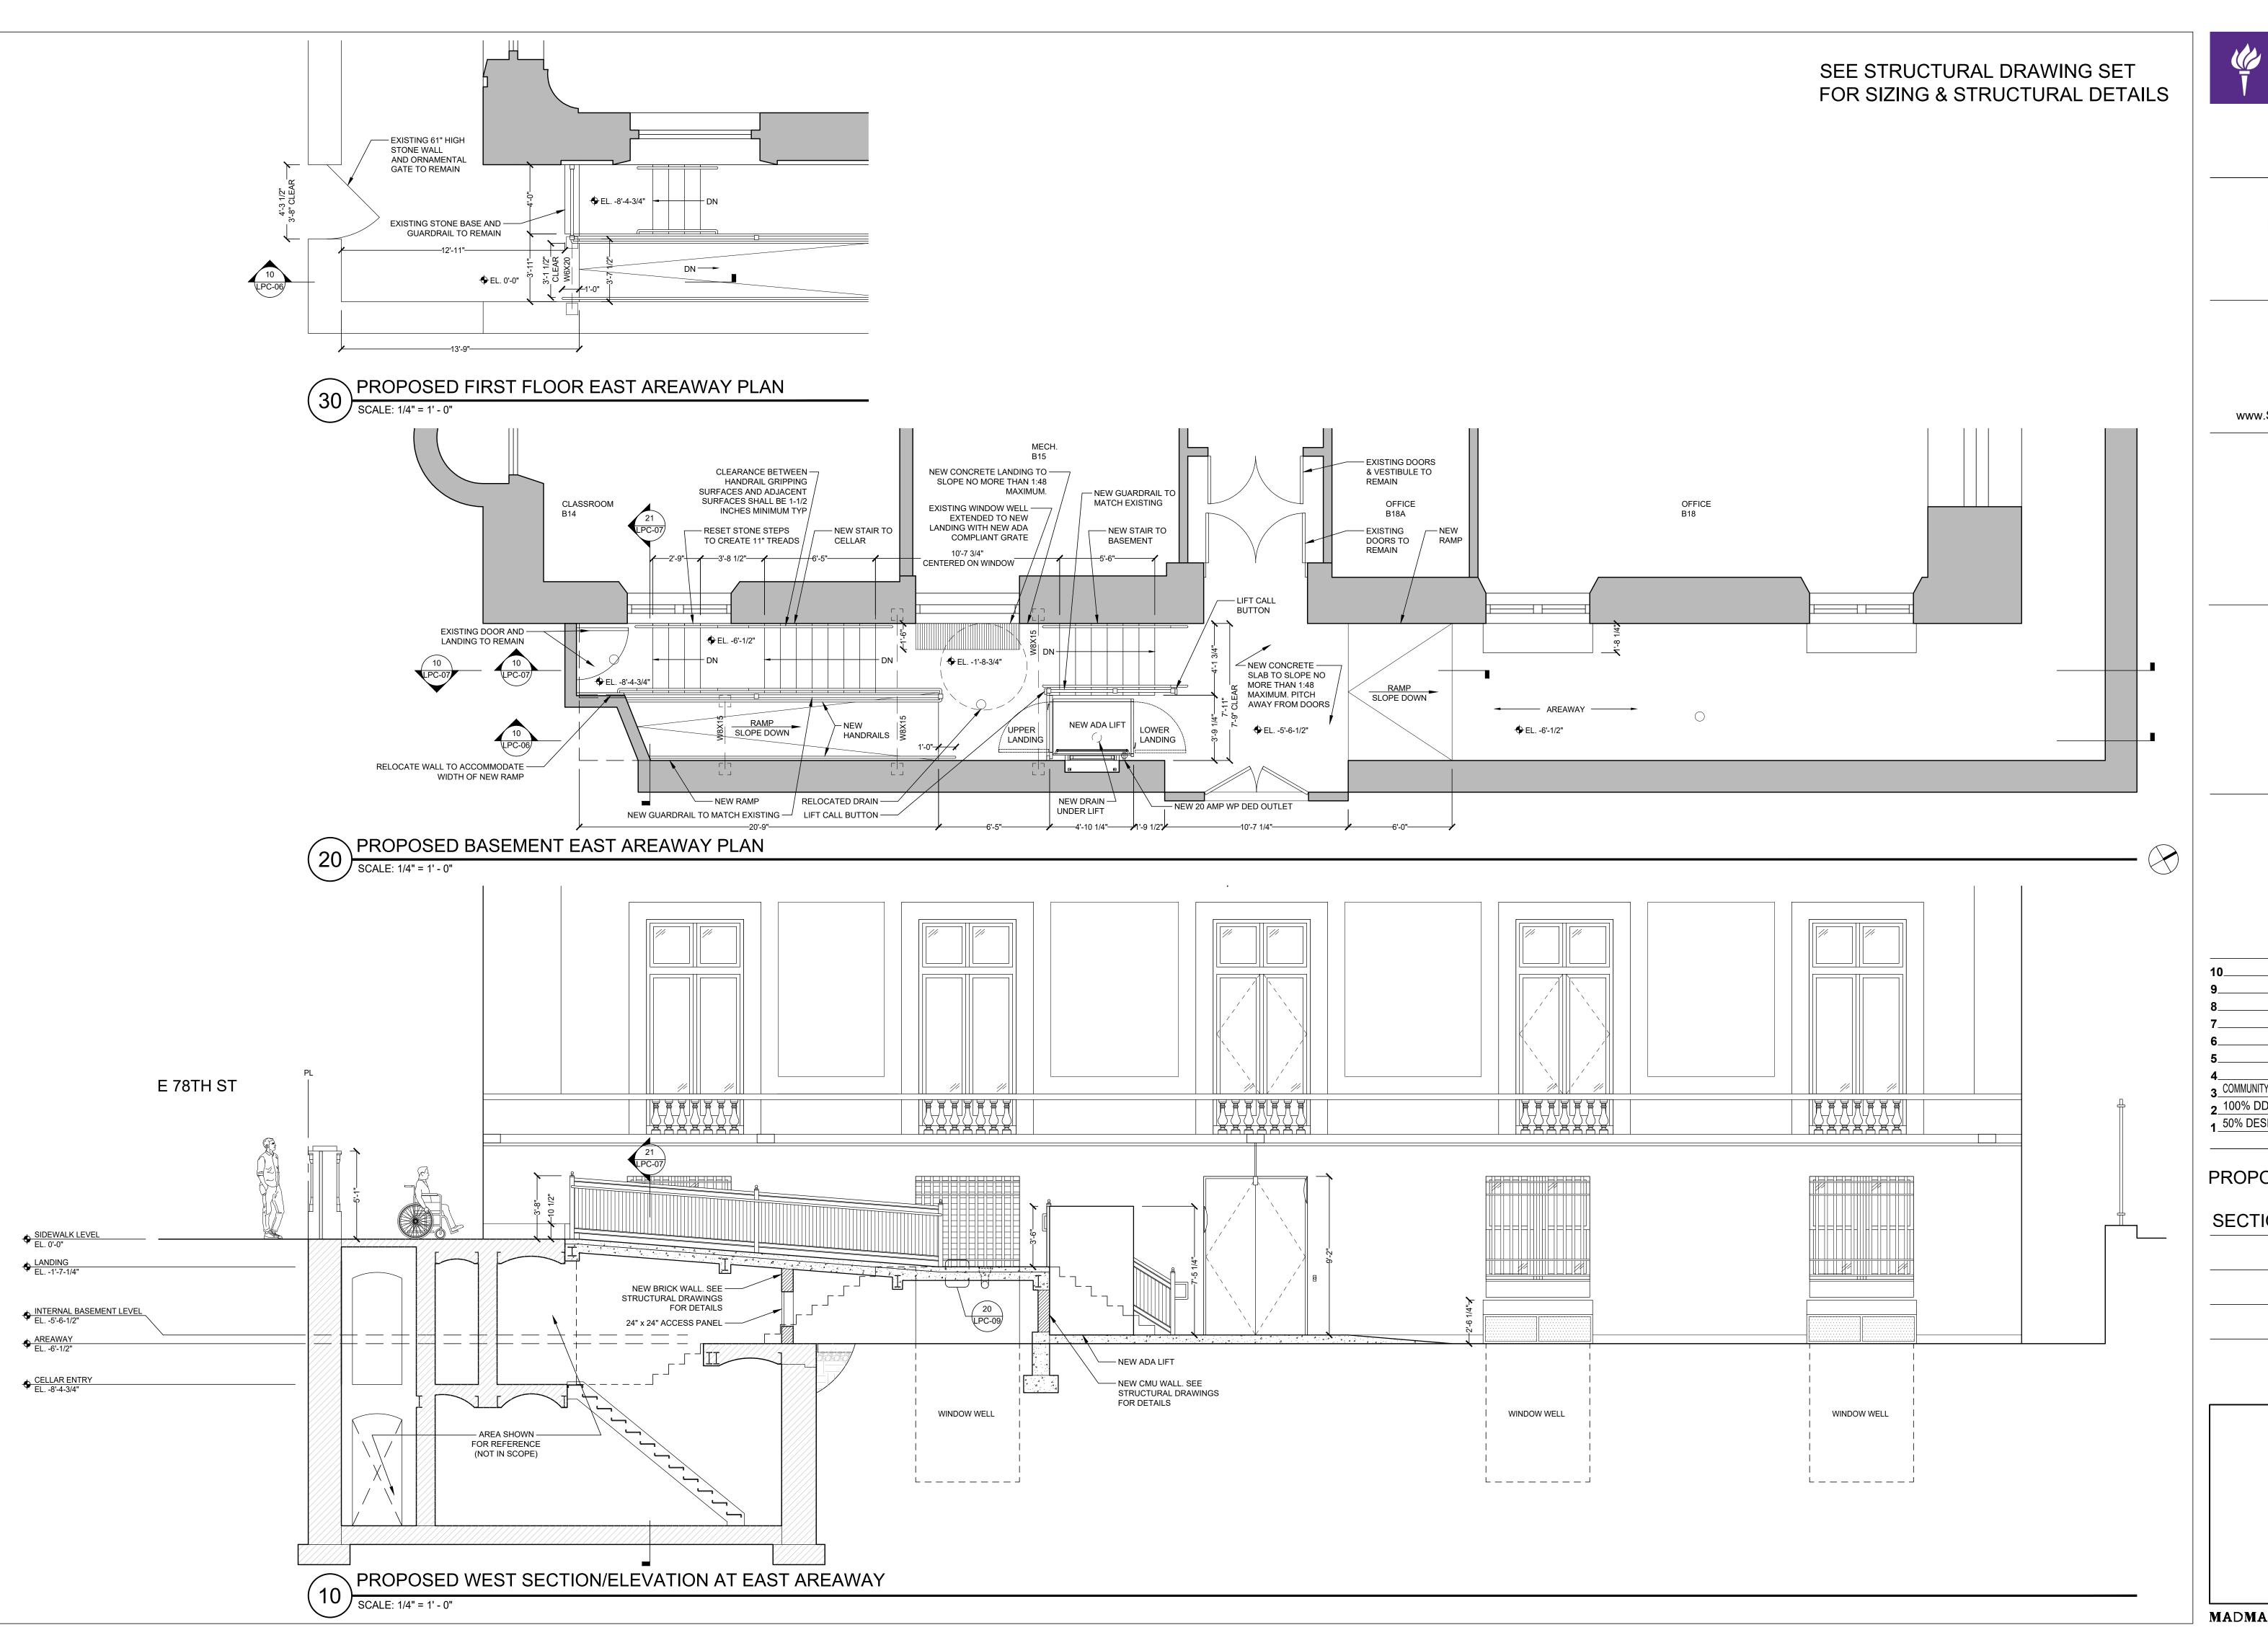


BASEMENT REFERENCE PLAN

project number
2201A
date
12.09.24
scale
AS NOTED







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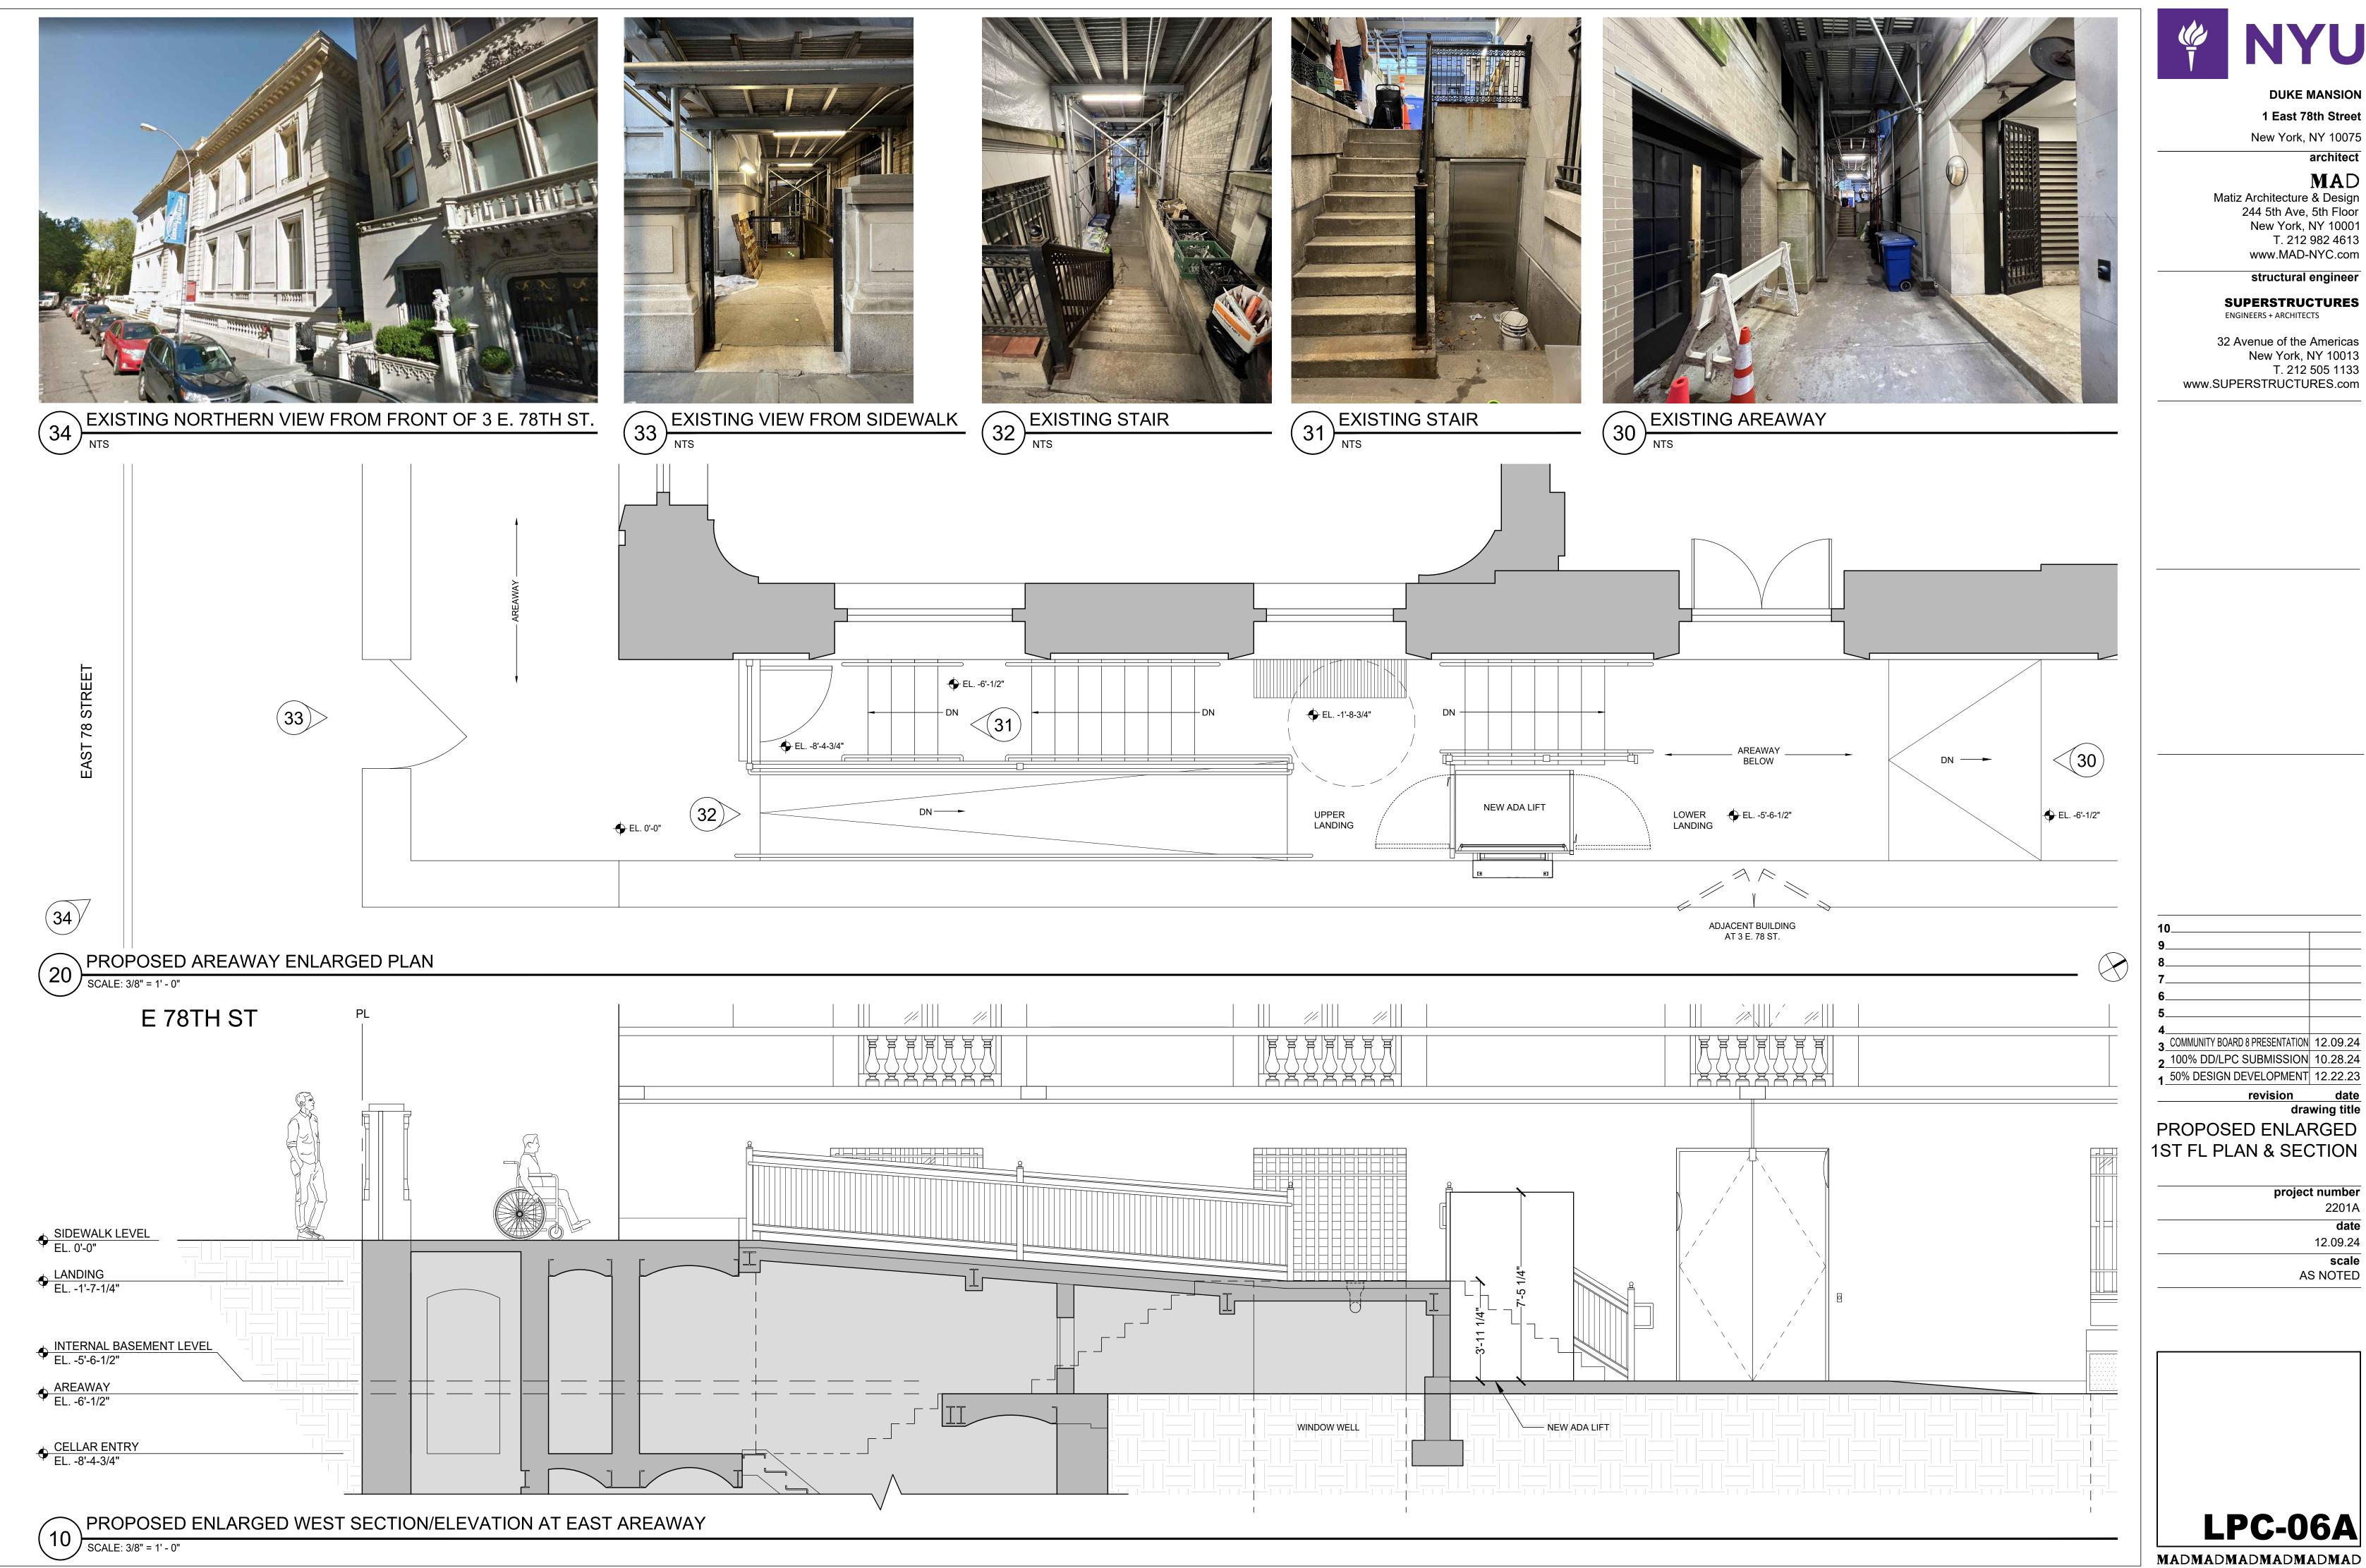
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3 COMMUNITY BOARD 8 PRESENTATION 12.09.24 100% DD/LPC SUBMISSION 10.28.24 50% DESIGN DEVELOPMENT 12.22.23 n date drawing title PROPOSED BASEMENT & 1ST FL PLAN, **SECTION & ELEVATION** project number 2201A

LPC-06

12.09.24

scale AS NOTED





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COMMUNITY BOARD 8 PRESENTATION 12.09.24 100% DD/LPC SUBMISSION 10.28.24 50% DESIGN DEVELOPMENT 12.22.23 on date drawing title PROPOSED ENLARGED 1ST FL PLAN & SECTION

project number 2201A

12.09.24

scale AS NOTED

LPC-06A



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SECTIONS

project number

2201A


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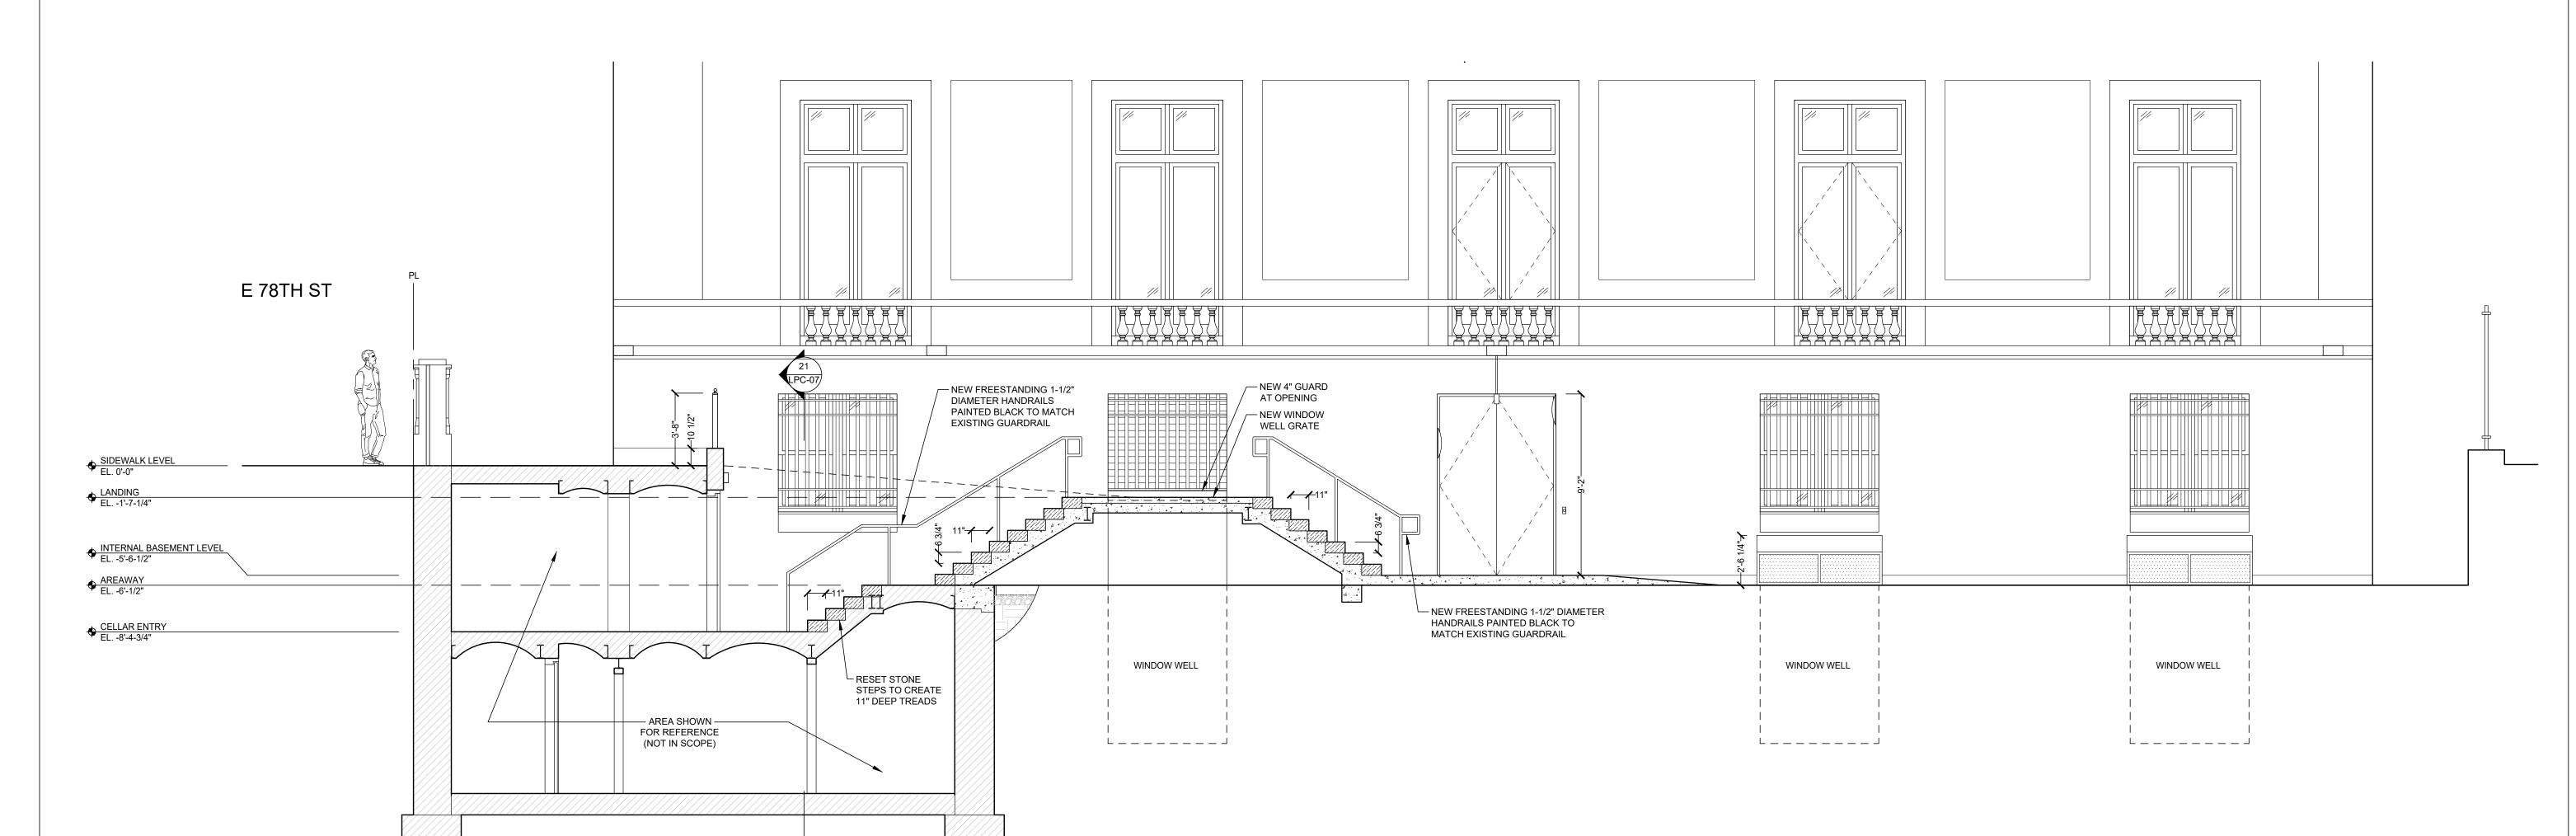
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scale





PROPOSED WEST SECTION/ELEVATION AT EAST AREAWAY

(10) SCALE: 1/4" = 1' - 0"

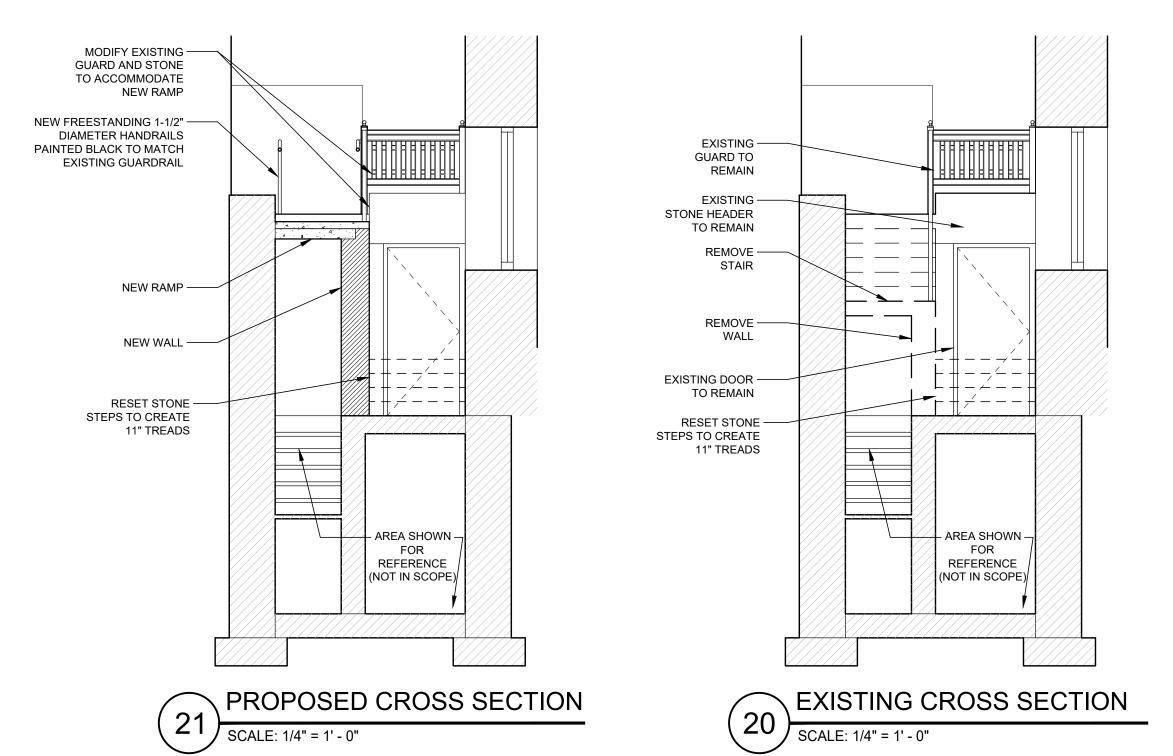

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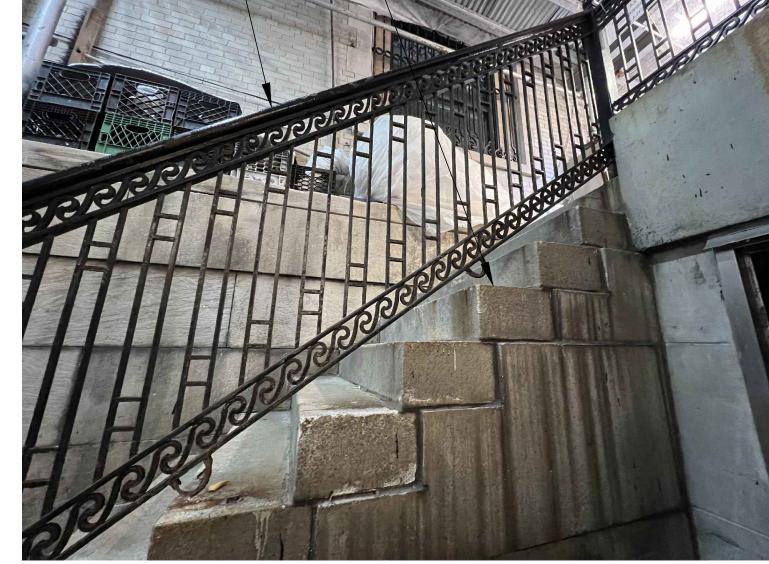
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THIS SECTION OF GUARD RAIL TO BE ALTERED TO ACCOMMODATE NEW RAMP




EXISTING DECORATIVE RAILING TO BE REMOVED, SALVAGED -

AND REUSED WHERE POSSIBLE



EXISTING STONE STEPS TO BE REMOVED, SALVAGED AND REUSED WHERE POSSIBLE

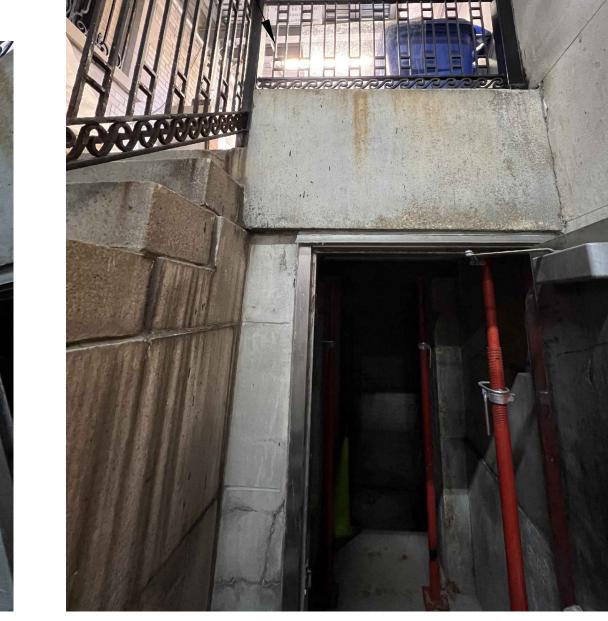


20 EXISTING GUARDRAIL



\ EXISTING RAILING & NEWEL POST



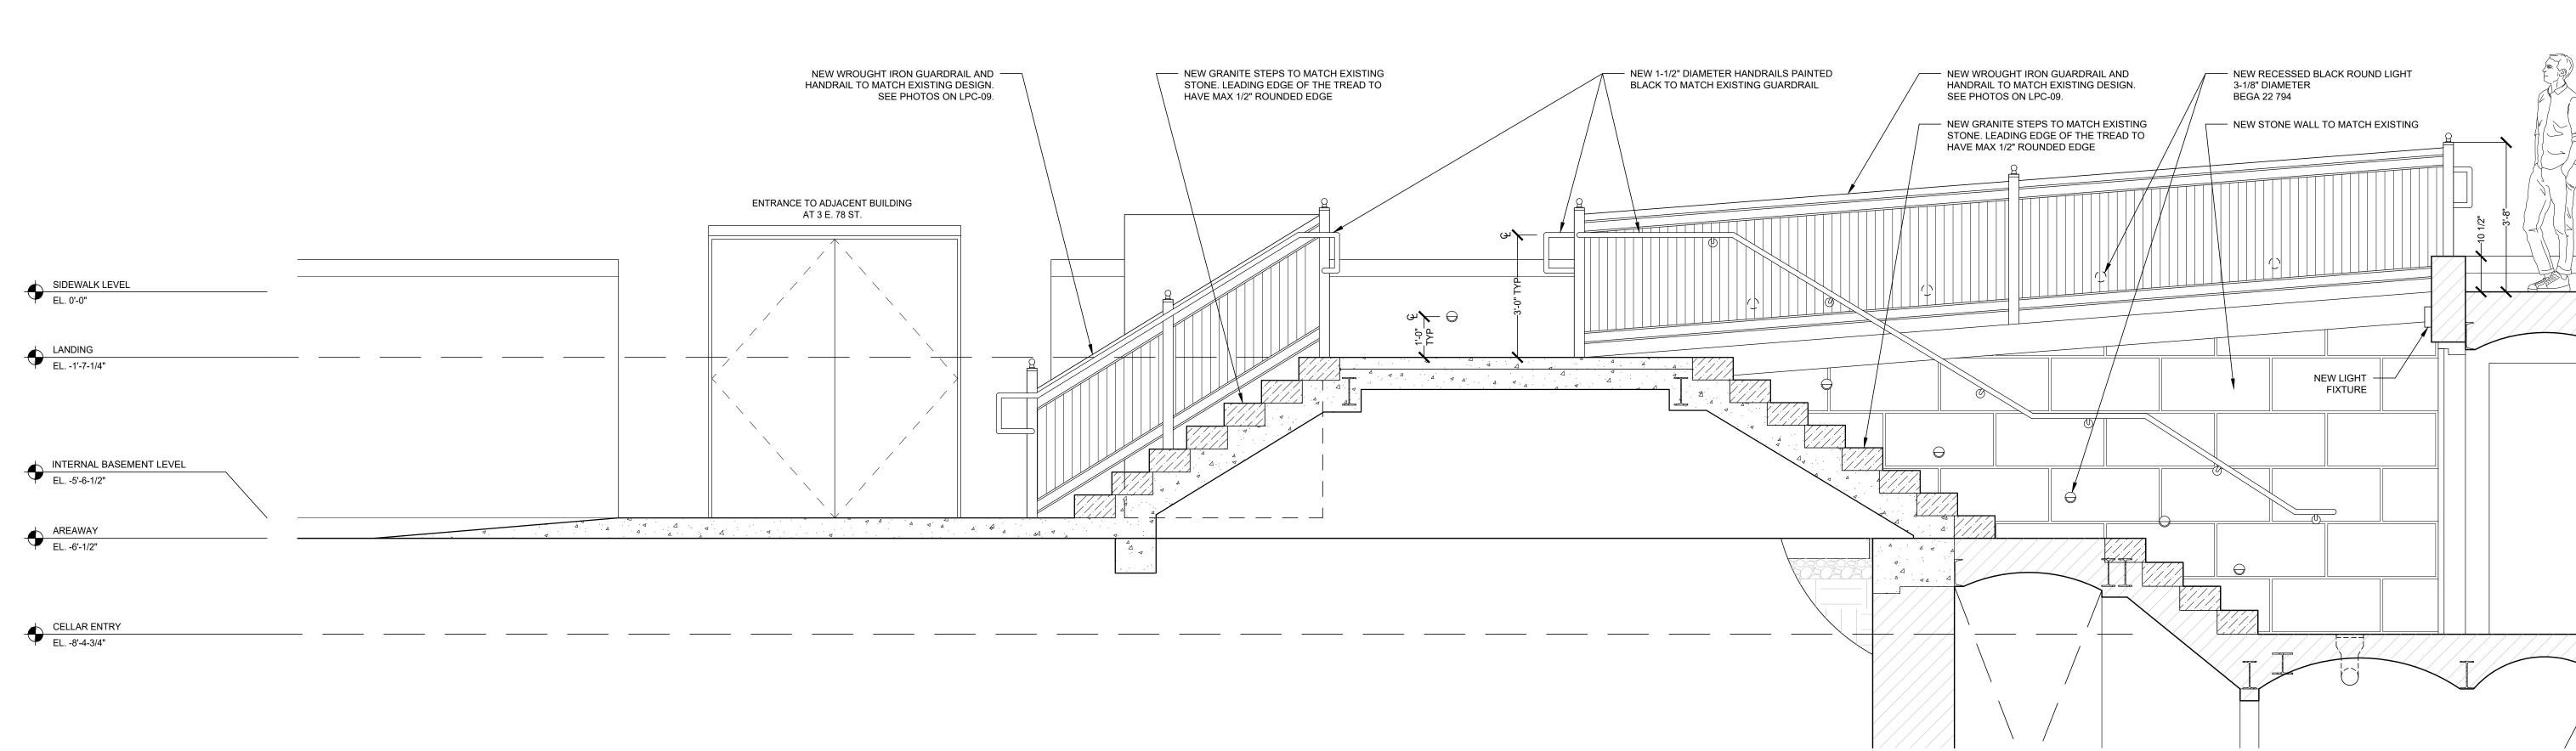

LPC-09

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COMMUNITY BOARD 8 PRESENTATION 12.09.24 2 100% DD/LPC SUBMISSION 10.28.24 50% DESIGN DEVELOPMENT 12.22.23

n date drawing title

HANDRAIL &

GUARDRAIL

project number

2201A

12.09.24

AS NOTED

scale

PROPOSED EAST SECTION/ELEVATION AT EAST AREAWAY

EXISTING WINDOW WELL EXTENDED TO NEW LANDING LEVEL WITH NEW ADA

COMPLIANT GRATE. COORDINATE WITH STRUCTURAL CONSULTANT

EXISTING WINDOW WELL GRATE

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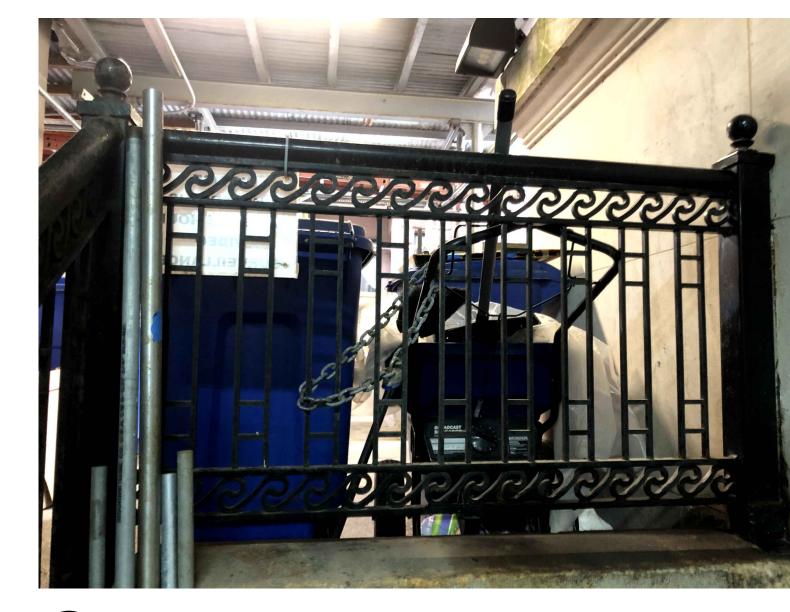
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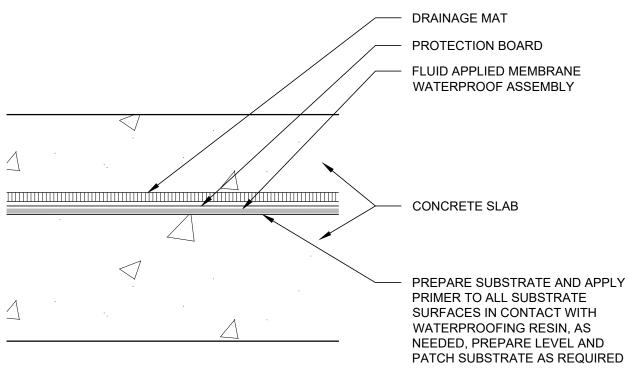





\ EXISTING GUARDRAIL TOP



\ EXISTING GUARDRAIL




TYP WATERPROOFING DETAIL

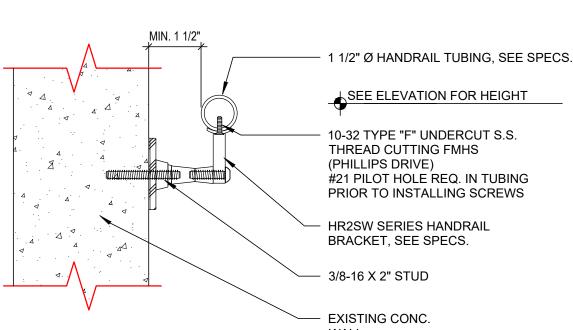

WALL MOUNTED HANDRAIL SECTION (12) SCALE: 3"=1'-0"

STAIR LENGTH ONE TREAD LENGTH 1'-0" PAST FIRST -__ VARIES SEE DWGS PAST STEP NOSING, TYP. ALL RAILINGS TO BE PREPPED & FINISH PAINTED IN BLACK TO MATCH EXISTING GUARDRAIL CRL HR20BS98 S.S. 1 1/2" DIAMETER .05 PIPE RAIL TUBING CRL HR2SW SERIES WALL MOUNTED HAND RAIL BRACKET BRUSHED S.S.

WALL MOUNTED HANDRAIL DETAIL SCALE: 1"=1'-0"

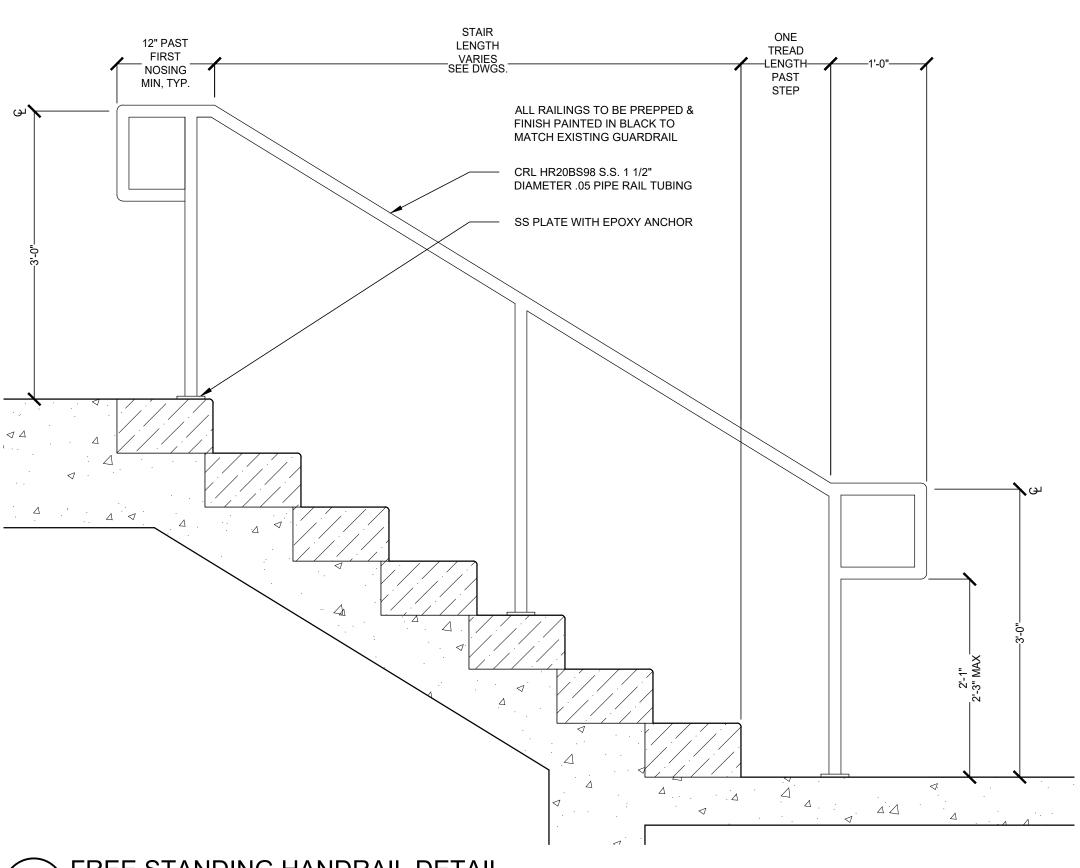

\FREE STANDING HANDRAIL DETAIL

LPC-08

3 COMMUNITY BOARD 8 PRESENTATION 12.09.24

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PHOTOS &

DETAILS

project number


2201A

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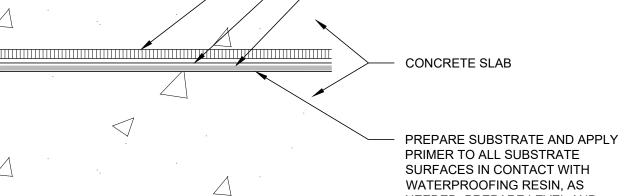
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scale






EXISTING GUARDRAIL MIDDLE

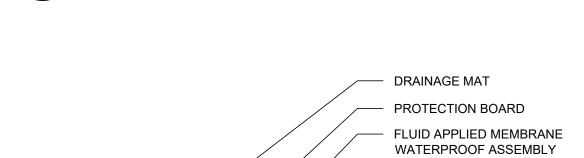



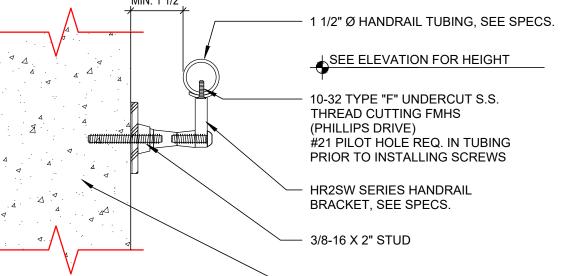




DRIVE TOWER TO BE

EMBEDDED IN WALL

UNENCLOSED LIFT FOR REFERENCE


Figure 3: Floor loading diagram

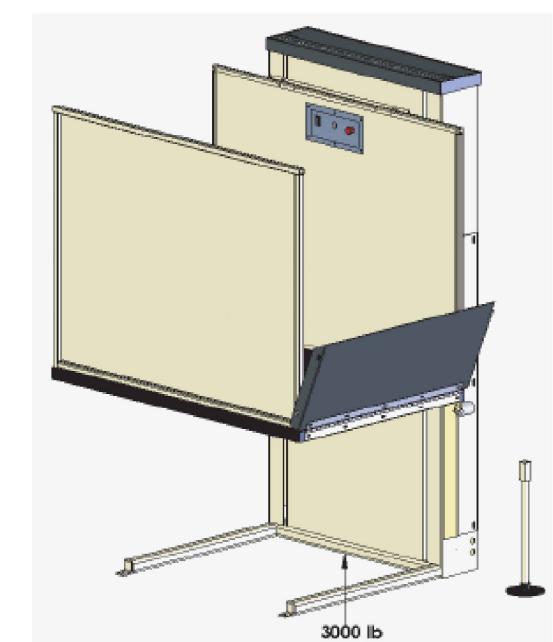

	① ② ③ ③ ④ ④ ⑤ ⑤	
	Number	Des
	1	Front t
	2	Car operatin
	3	Side go Safety und
	4	Safety und
A Commence of the Commence of	5	Sélf suj
3000 lb	6	Tow

TYPICAL FLOOR LOADING DIAGRAM


Figure 1: Typical lift, outdoor, unenclosed, no platform gate

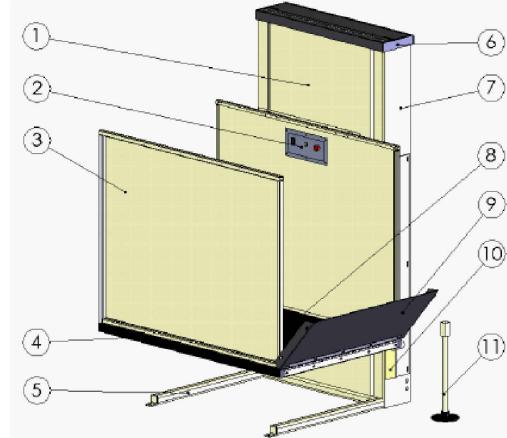

Number	Description	Number	Description
1	Front tower panel	7	Tower
2	Car operating panel (C.O.P.)	8	Non-skid platform
3	Side guard panel	9	Automatic access ramp
4	Safety underpan sensors	10	Access ramp channel
5	Self support base	11	Manual lowering device
6	Tower cover	-	-

TYPICAL LIFT SPECIFICATIONS $(21)^{11}$

Figure 2: Drive tower

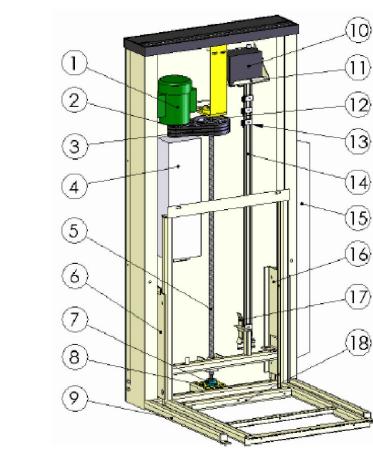

Number	Description	Number	Description
1	Motor	10	Battery (optional)
2	Main pulley	11	Battery tray
3	V strap	12	Pulley
4	Controller box	13	Limit switches (may vary)
5	Acme screw	14	Unistrut
6	Left roller guide	15	Access ramp channel
7	Lower bearing	16	Right roller guide
8	Lower bearing plate	17	Cam assembly
9	Self support base	18	Carriage assembly

DRIVE TOWER SPECIFICATIONS

NTS

LIFT TO BE IN PEBBLE GREY FINISH. ACTUAL COLOR MAY VARY RAL 7032



RECESSED BLACK ROUND LIGHT 3-1/8" DIAMETER BEGA 22 794

\ LIGHT SPECIFICATIONS

SAVARIA MULTILIFT UNENCLOSED VERTICAL PLATFORM LIFT TYPE 2 WITH PLATFORM GATE, UNENCLOSED HOISTWAY, 36" CAB

Multilift specifications

Applications	Residential (indoor/outdoor); commercial (U.S.A.)		
Load capacity	750 lb (340 kg)		
Maximum travel distance	48" (1219 mm); optionally 72" (1829 mm)		
Levels serviced	2		
Travel speed	8 ft/min (0.04 m/s)		
Noise level (for typical installation)	65.9 dBA (up direction); 65.0 dBA (down direction) Measured at a height of 1m, distance of 1m, in front of the motor with all panels on		
Cab types/sizes	Type 2 (enclosed and unenclosed hoistway): • 34" x 48" (863 mm x 1219 mm) • 34" x 54" (863 mm x 1371 mm) • 34" x 60" (863 mm x 1524 mm)		
	Type 3/4: (enclosed and unenclosed hoistway): • 35" x 47" (889 mm x 1194 mm) • 35" x 53" (889 mm x 1346 mm) • 35" x 59" (889 mm x 1499 mm)		
	Type 2 with platform gate (unenclosed hoistway): - 36" x 48" (914 mm x 1219 mm) - 36" x 54" (914 mm x 1371 mm) - 36" x 60" (914 mm x 1524 mm)		
	Type 3/4 with platform gate (unenclosed hoistway): • 36" x 47" (914 mm x 1194 mm) • 36" x 53" (914 mm x 1346 mm) • 36" x 59" (914 mm x 1499 mm)		
	All enclosure -Type 2, Type 3, Type 3 with 45" opening, Type 4, Type 4 with 45" opening • 36" x 48" (914 mm x 1219 mm) • 36" x 54" (914 mm x 1371 mm) • 36" x 60" (914 mm x 1524 mm)		
	Type 2, 3, or 4 (with/without platform gate and with enclosure) • 42" x 48" (1067 mm x 1219 mm)		
	• 42" x 54" (1067 mm x 1371 mm) • 42" x 60" (1067 mm x 1524 mm)		
	NOTE that the 42" wide cab units are not self-supporting and need wall mounting.		
Side guard panels	42 1/8" (1070 mm) side guard panels on platform		
• The second • The	Front/rear access - standard (platform Type 2)		
Cab access	90 degree access - optional (platform Type 3 and 4)		
Power supply	120 VAC, 15 A, 60 Hz, single phase (must be a dedicated electrical line)		
	Acme screw and back-up nut		
Drive system	1 hp (0.75 Kw) motor, 110 VAC		
	Optional 1 hp, 24-volt battery model available		
Control system	Electronic-free relay logic controller		
Finish	Beige electrostatic powder coat paint on all steel surfaces and vacuum-formed plastics		
Features	Call/send stations at landings Continuous-pressure type buttons Operating control buttons on platform Emergency manual lowering/raising device Low-voltage controls Underpan sensors		
	Non-skid platform surface Automatic access ramp (16"); field reversible to suit installation needs Emergency stop button		

LIFT SPECIFICATIONS



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LIFT SPECIFICATIONS

project number 2201A 12.09.24 scale AS NOTED

LPC-10